
401 WEST GANNON AVENUE

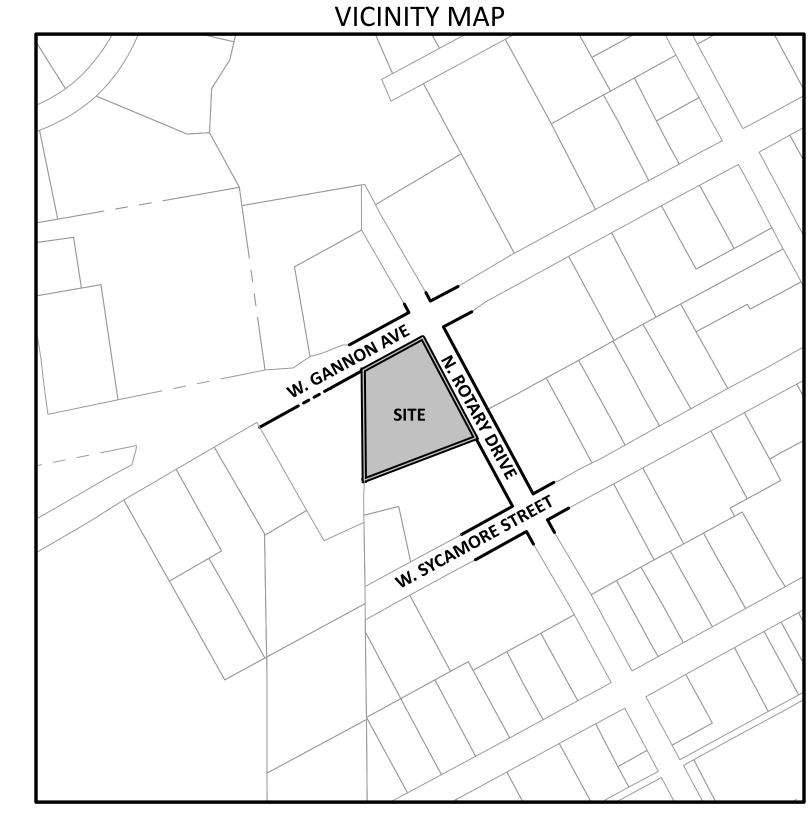

SITE PLAN DRAWINGS

ZEBULON, NC

MARCH 1, 2023

CLIENT

MERIDIAN PROPERTIES GROUP, LLC 4030 WAKE FOREST ROAD, SUITE 100 RALEIGH, NC 27609 919-621-4648

EROSION CONTROL, STORMWATER

AND FLOODPLAIN MANAGEMENT

APPROVED

DATE

EROSION CONTROL \square S-

FLOOD STUDY

S-_

STORMWATER MGMT.

S-_

SHEET INDEX			
SHEET NO.	SHEET NAME	MOST CURRENT REVISION DATE	
C1.0	EXISTING CONDITIONS PLAN	3/1/2023	
C1.1	STAGING AND DEMOLITION PLAN	3/1/2023	
C2.0	SITE PLAN	3/1/2023	
C3.0	UTILITY PLAN	3/1/2023	
C4.0	GRADING PLAN	3/1/2023	
C5.0	LANDSCAPE PLAN	3/1/2023	
C6.1	EROSION CONTROL PLAN STAGE 1	3/1/2023	
D1.1	TOWN OF ZEBULON DETAILS	3/1/2023	
D1.2	TOWN OF ZEBULON & SITE DETAILS	3/1/2023	
D2.1	EROSION CONTROL DETAILS	3/1/2023	
D3.1	RALEIGH SEWER DETAILS	3/1/2023	
D3.2	RALEIGH SEWER DETAILS	3/1/2023	
D4.1	RALEIGH WATER DETAILS	3/1/2023	
D4.2	RALEIGH WATER DETAILS	3/1/2023	



ATTENTION CONTRACTORS CONSTRUCTION CONTRACTOR RESPONSIBLE FOR THE EXTENSION OF WATER, SEWER AND/OR REUSE, AS APPROVED IN THESE PLANS, IS RESPONSIBLE FOR CONTACTING THE PUBLIC UTILITIES DEPARTMENT AT 919–996–4540 AT LEAST 24 HOURS PRIOR TO BEGINNING ANY OF THEIR CONSTRUCTION.

FAILURE TO NOTIFY BOTH CITY DEPARTMENTS IN ADVANCE OF BEGINNING CONSTRUCTION WILL RESULT IN THE ISSUANCE OF MONETARY FINES, AND REQUIRE REINSTALLATION OF ANY WATER OR SEWER FACILITIES NOT INSPECTED AS A RESULT OF THIS NOTIFICATION FAILURE TO CALL FOR INSPECTION, INSTALL A DOWNSTREAM PLUG, HAVE PERMITTED PLANS ON THE JOBSITE, OR ANY OTHER VIOLATION OF CITY OF RALEIGH STANDARDS WILL RESULT IN A FINE AND POSSIBLE EXCLUSION FROM FUTURE WORK IN THE CITY OF RALEIGH.

Water and Sewer Permits (If Applicable) The City of Raleigh consents to the connection and extension of the City's Public Sewe System as shown on this plan. The material and contruction methods used for this project shall conform to the standards and specifications of the City's Public Utilities Handbook. City of Raleigh Public Utilities Department Permit #_**S-XXXX** The City of Raleigh consents to the connection and extension of the City's Public Water System as shown on this plan. The material and contruction methods used for this project shall conform to the standards and specifications of the City's Public Utilities Handbook. City of Raleigh Public Utilities Department Permit #_\(\mathbb{W}\)=\(\mathbb{XXX}\)

CITY OF RALEIGH - PLANS AUTHORIZED FOR CONSTRUCTION Electronic Approval: THis approval is being issued electronically. This approval is valid only upon the signature of a City of Raleigh Review Officer Below. The City will retain a copy of the approvad plans. Any work authorized by this approval must proceed in accordance with the plans kept on file with the City. This electronic approval may not be edited once issued. Any modification to this approval once issued will invalidate this City of Raleigh Development Approval___

3/1/2023




PO Box 810 Rolesville, NC 27571 919-435-6395 NCBELS License P-0751


TOWN OF XXX PROJECT IDENTIFICATION #S


ZEBULON STANDARDS AND SPECIFICATIONS PRELIMINARY DRAWING - NOT RELEASED FOR CONSTRUCTION


ALL CONSTRUCTION SHALL BE IN


ACCORDANCE WITH TOWN OF

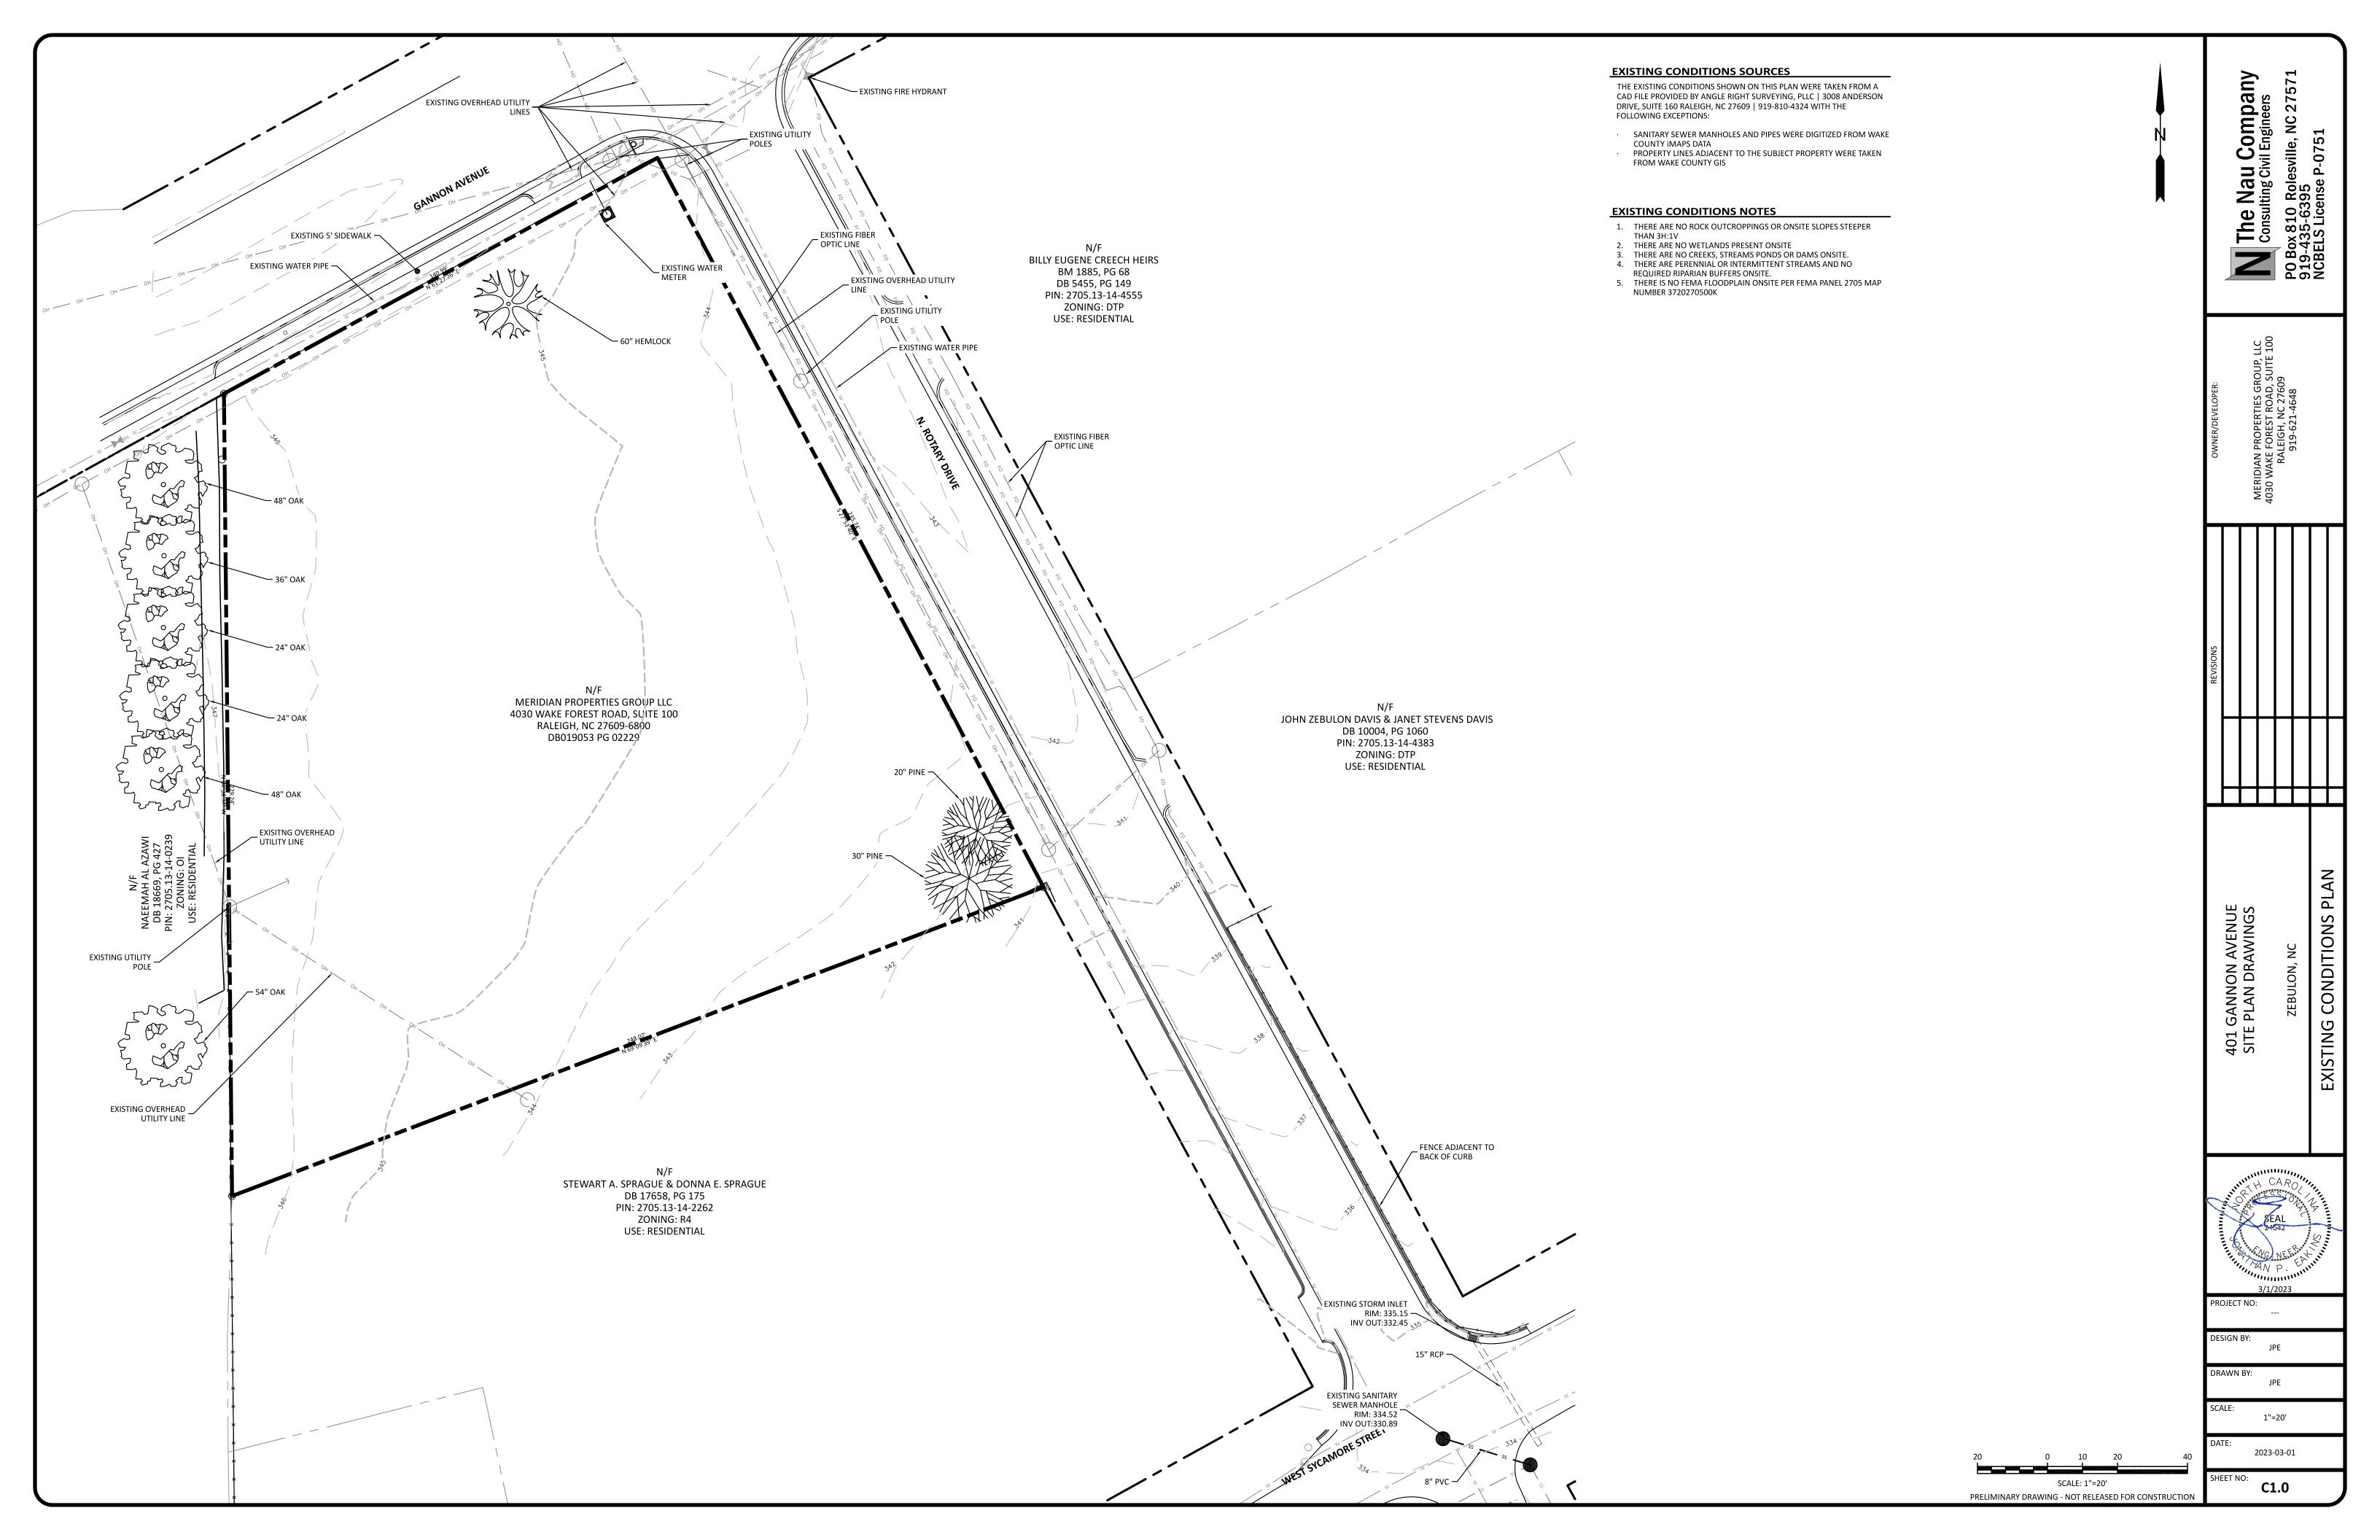


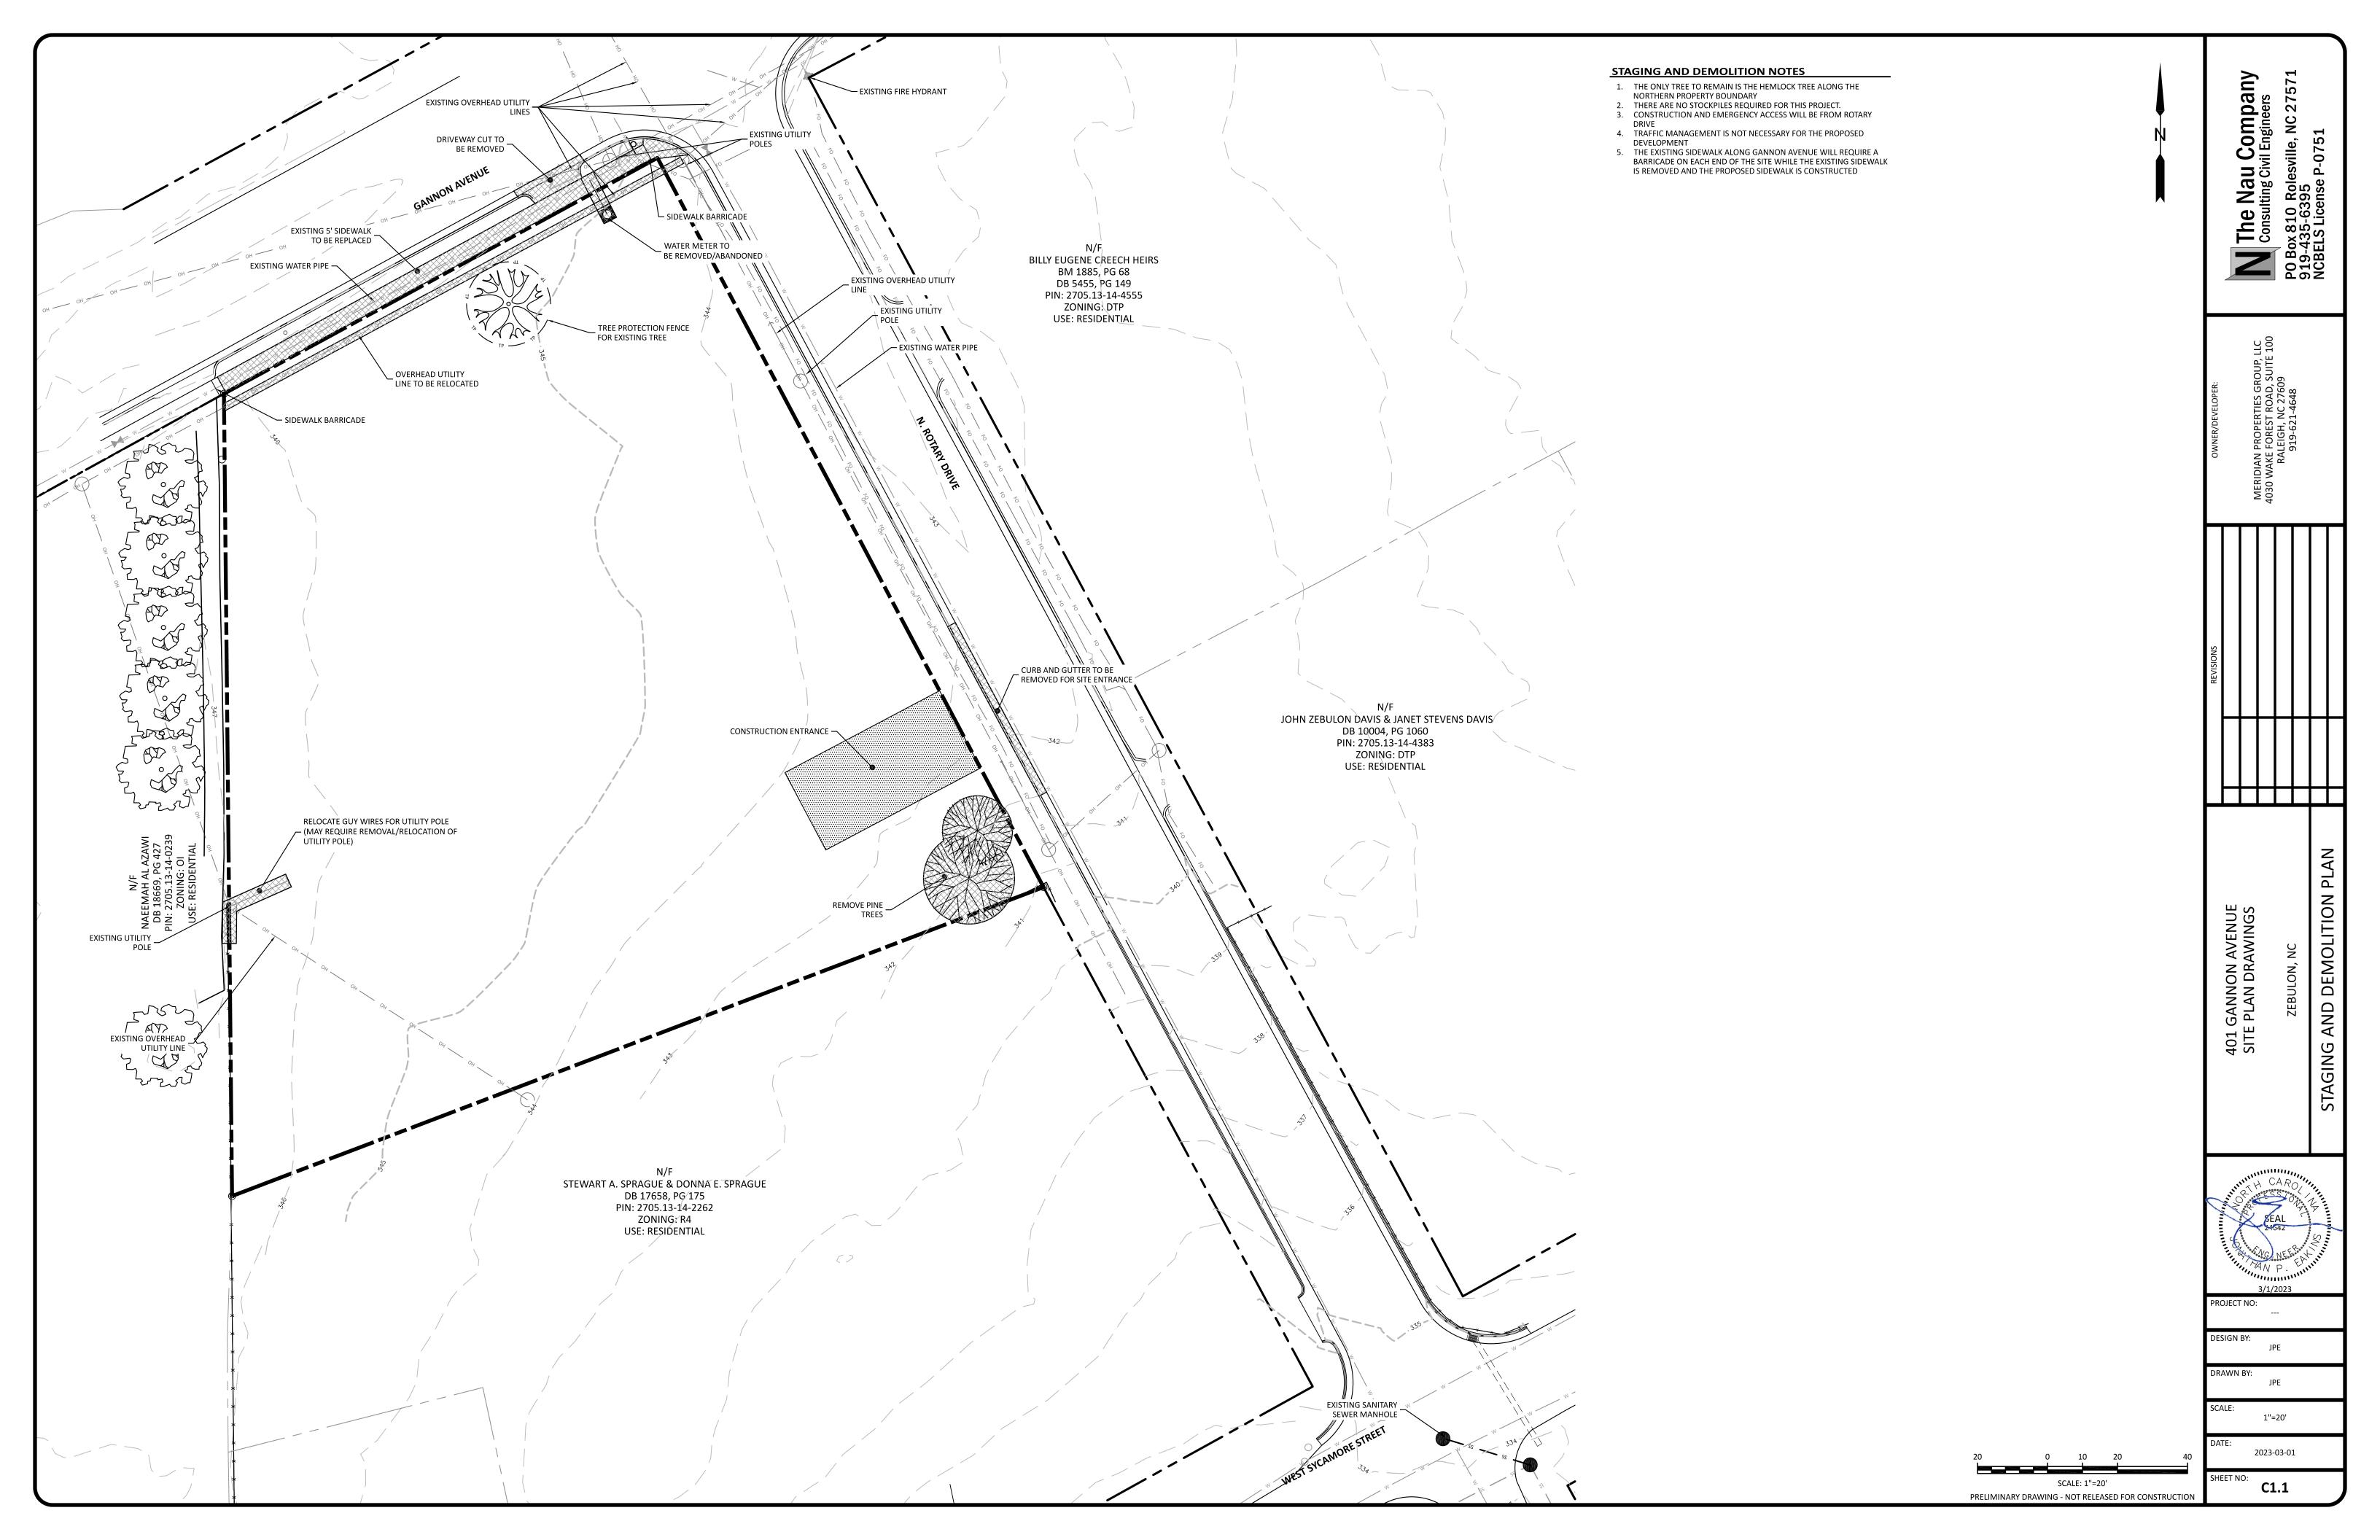


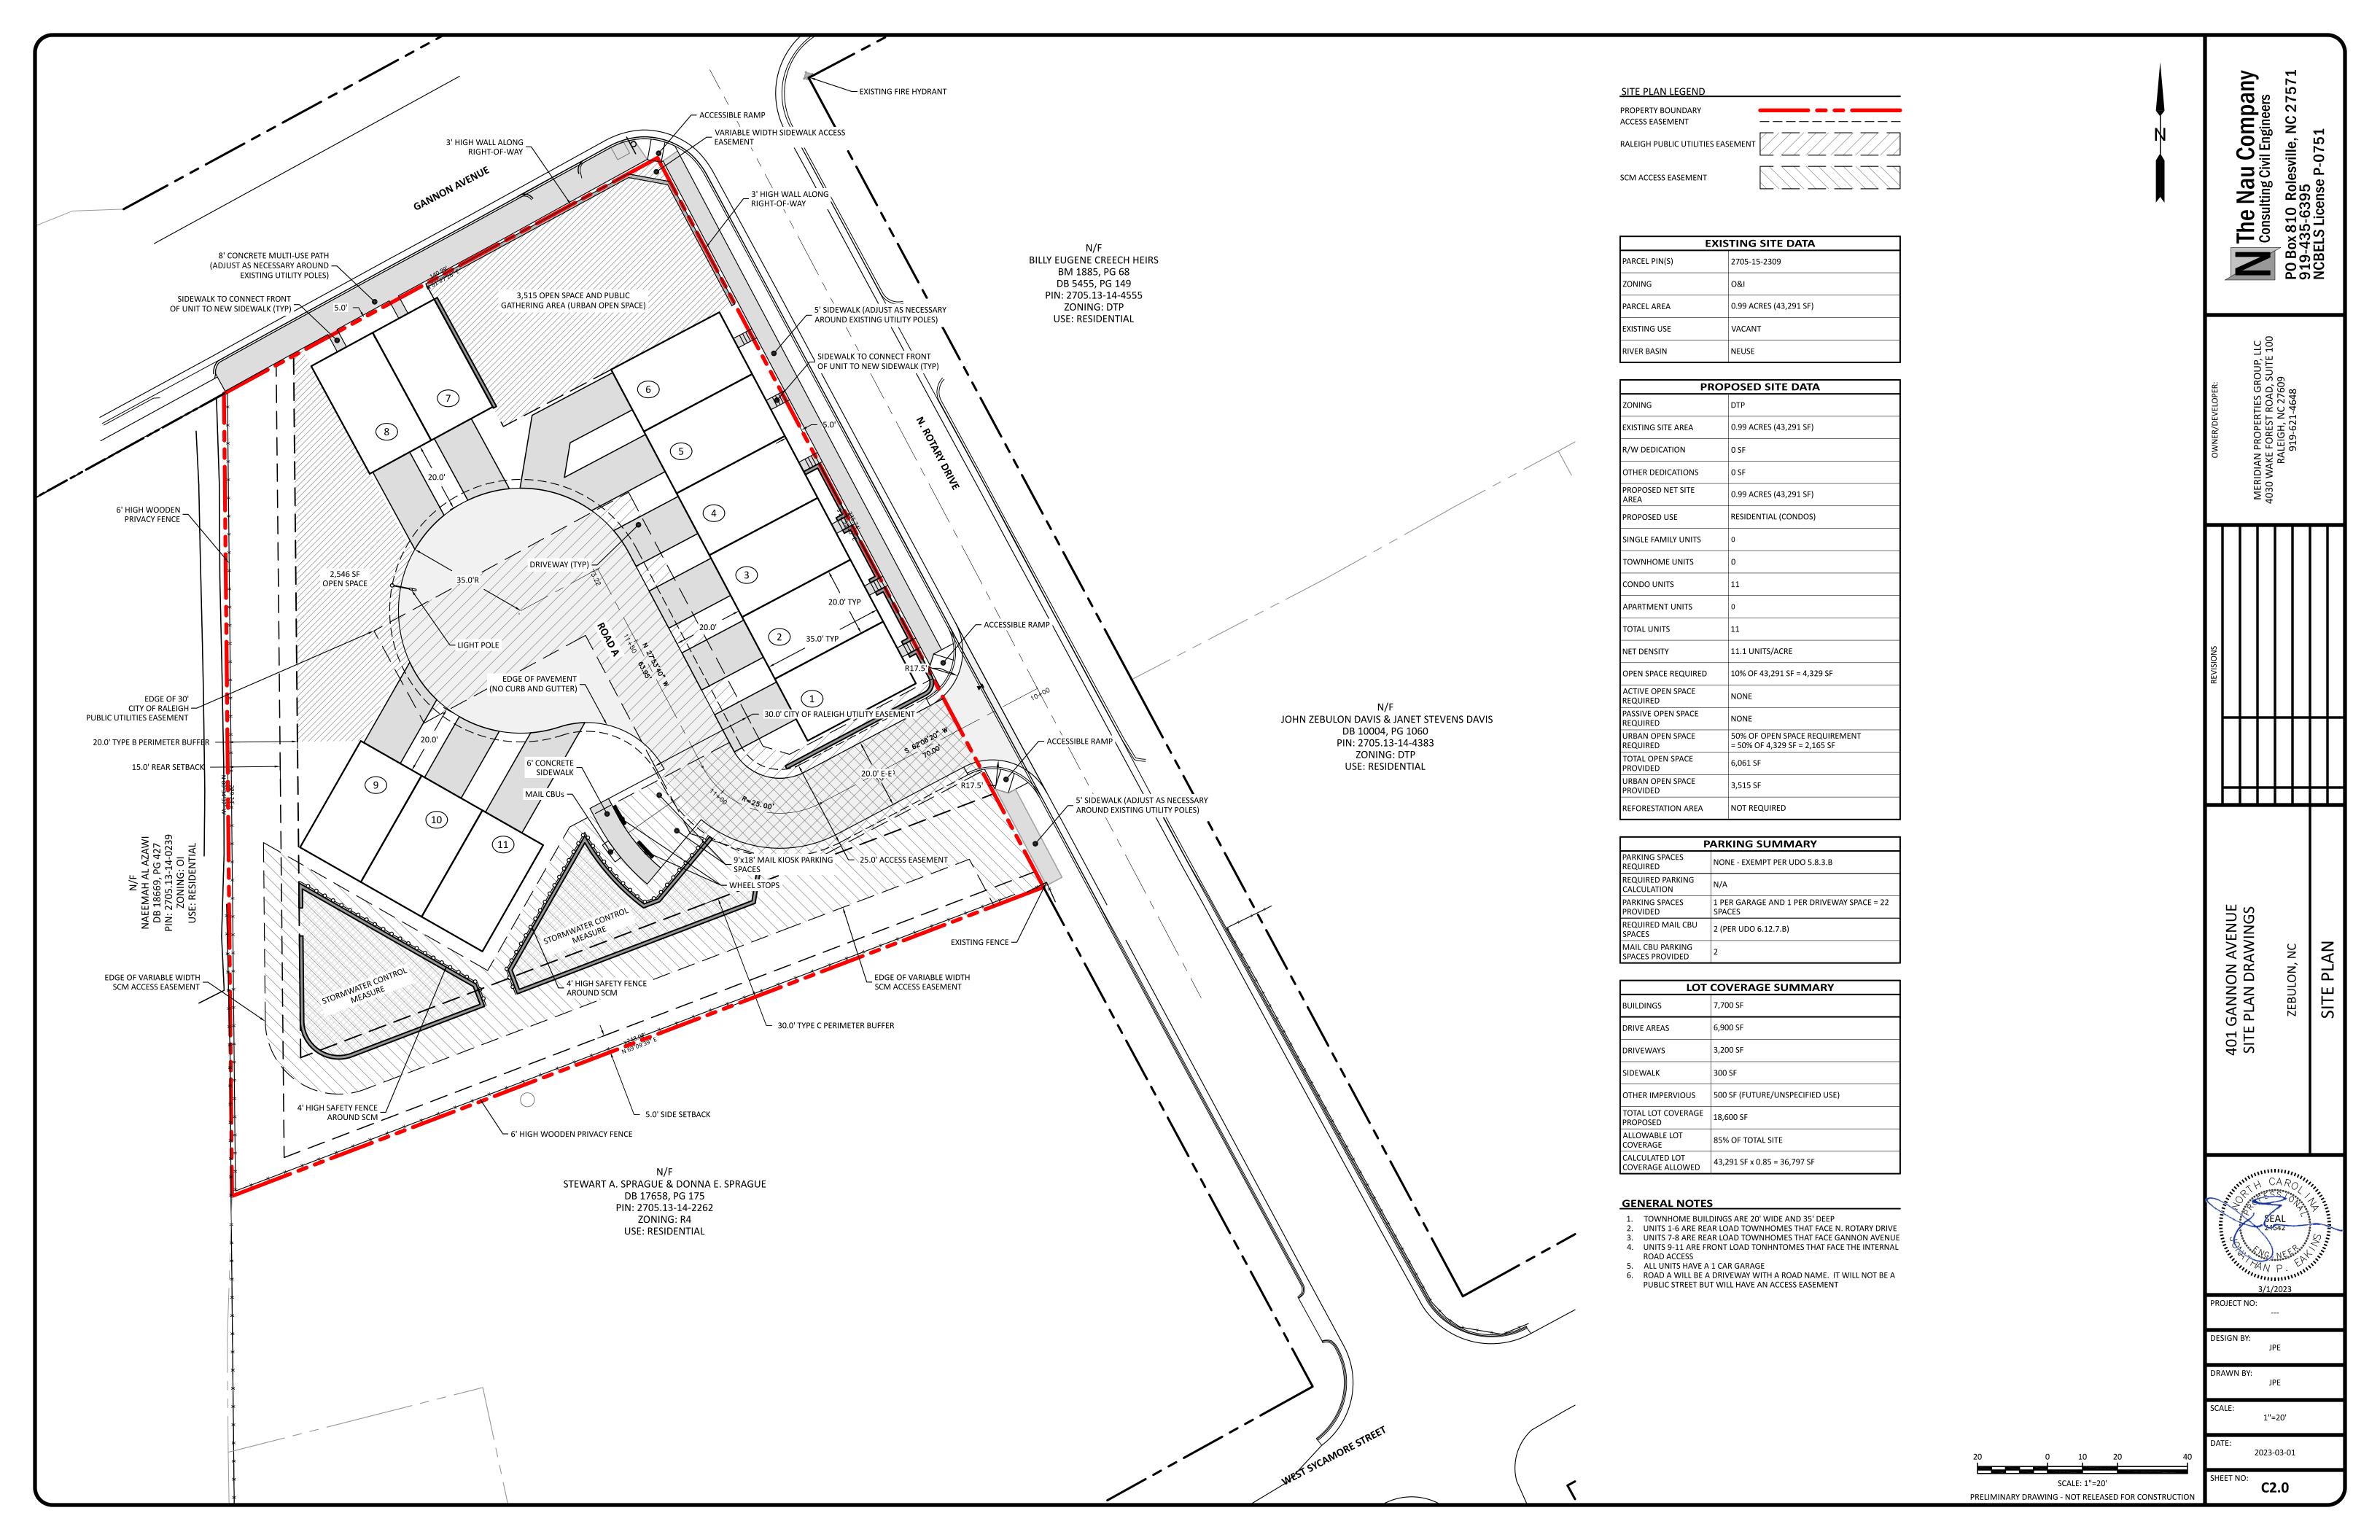


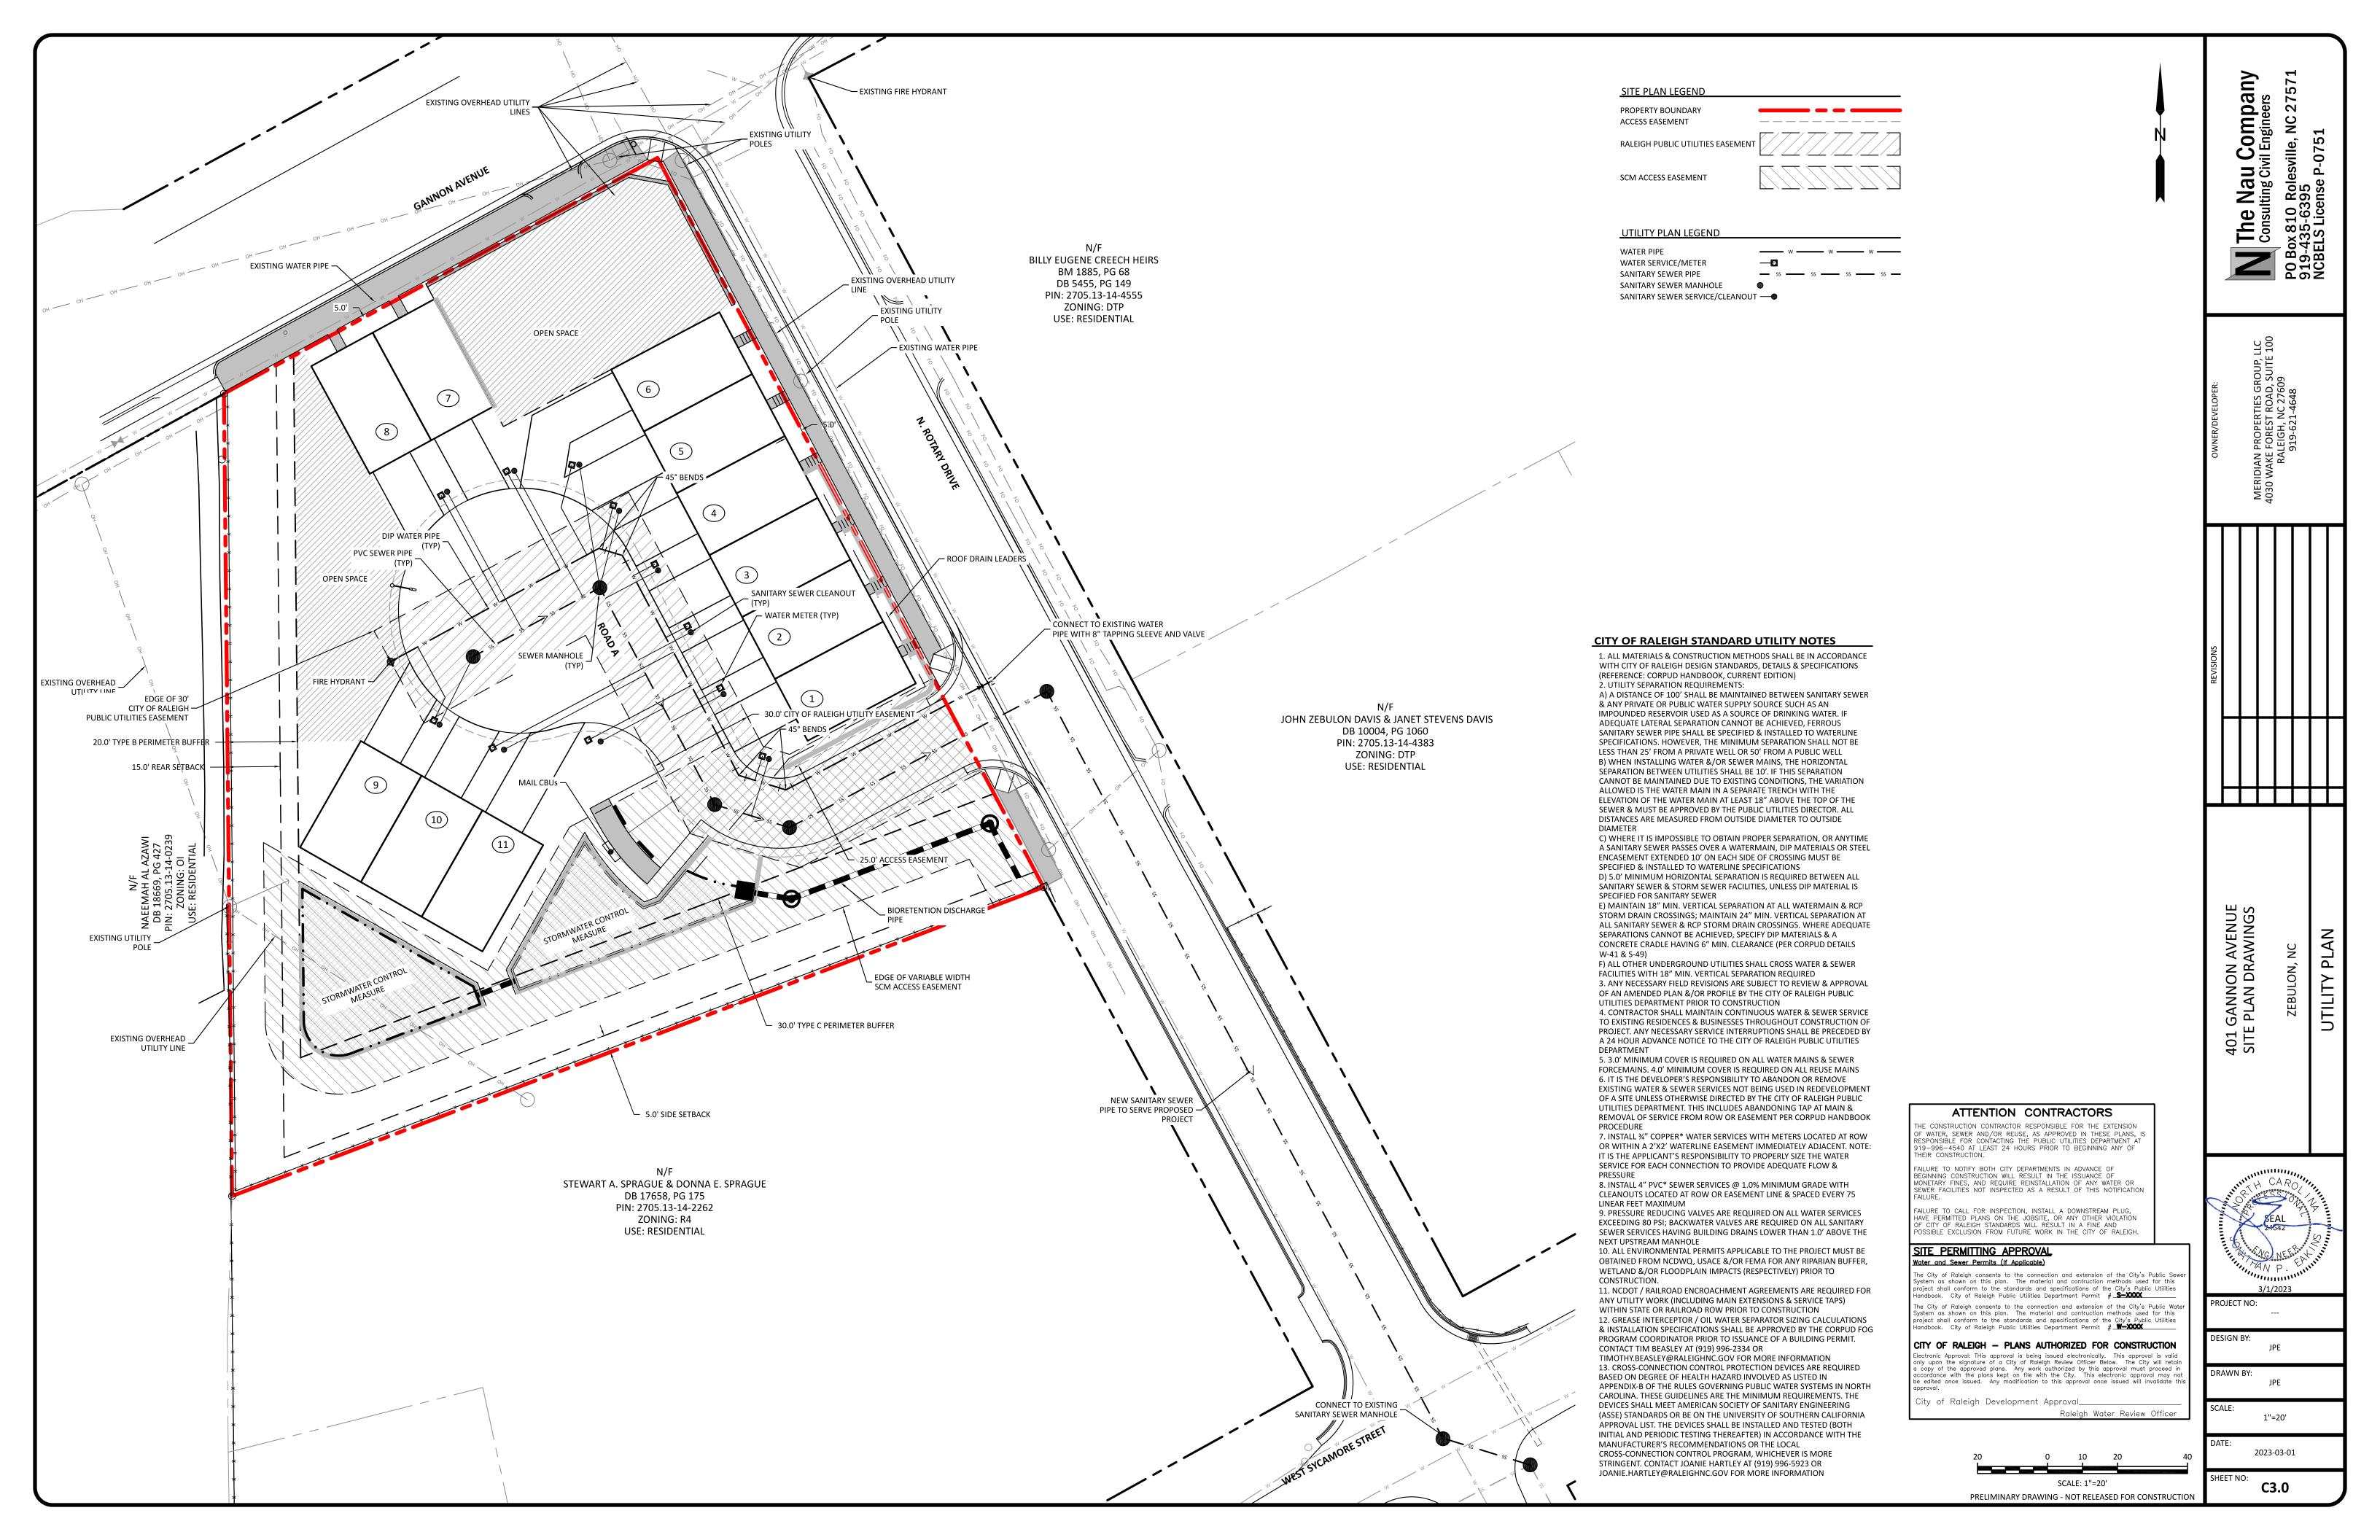


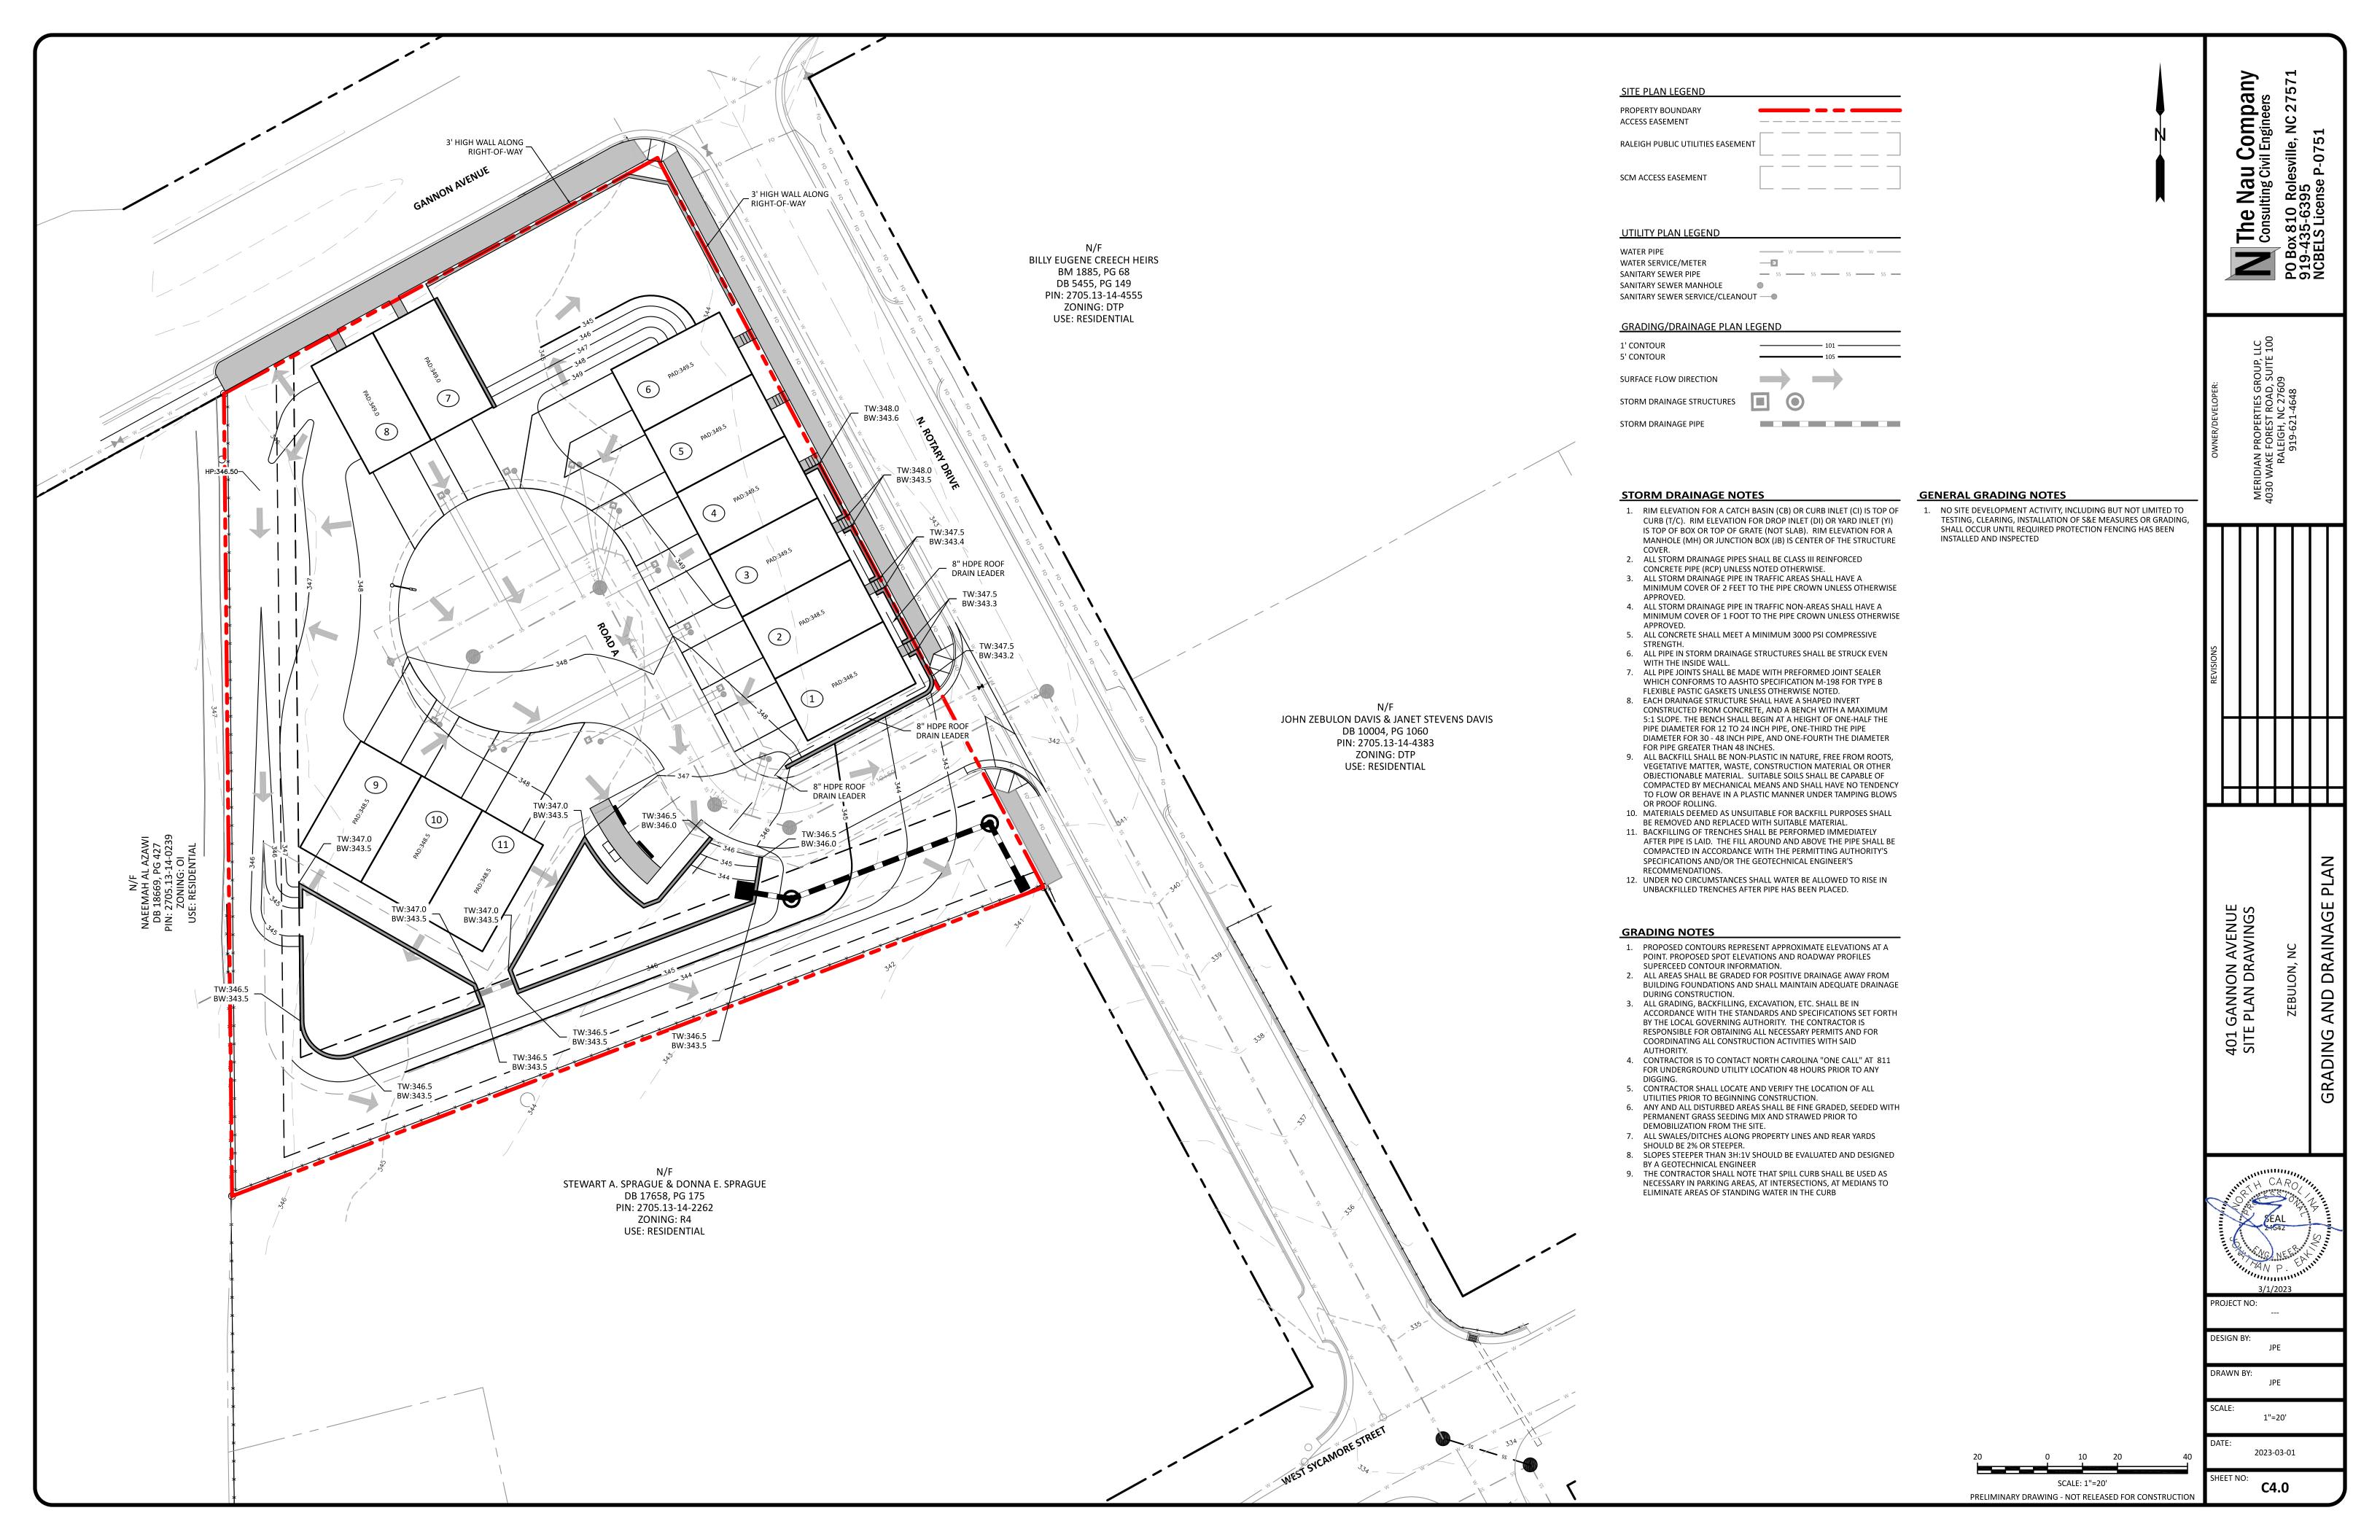


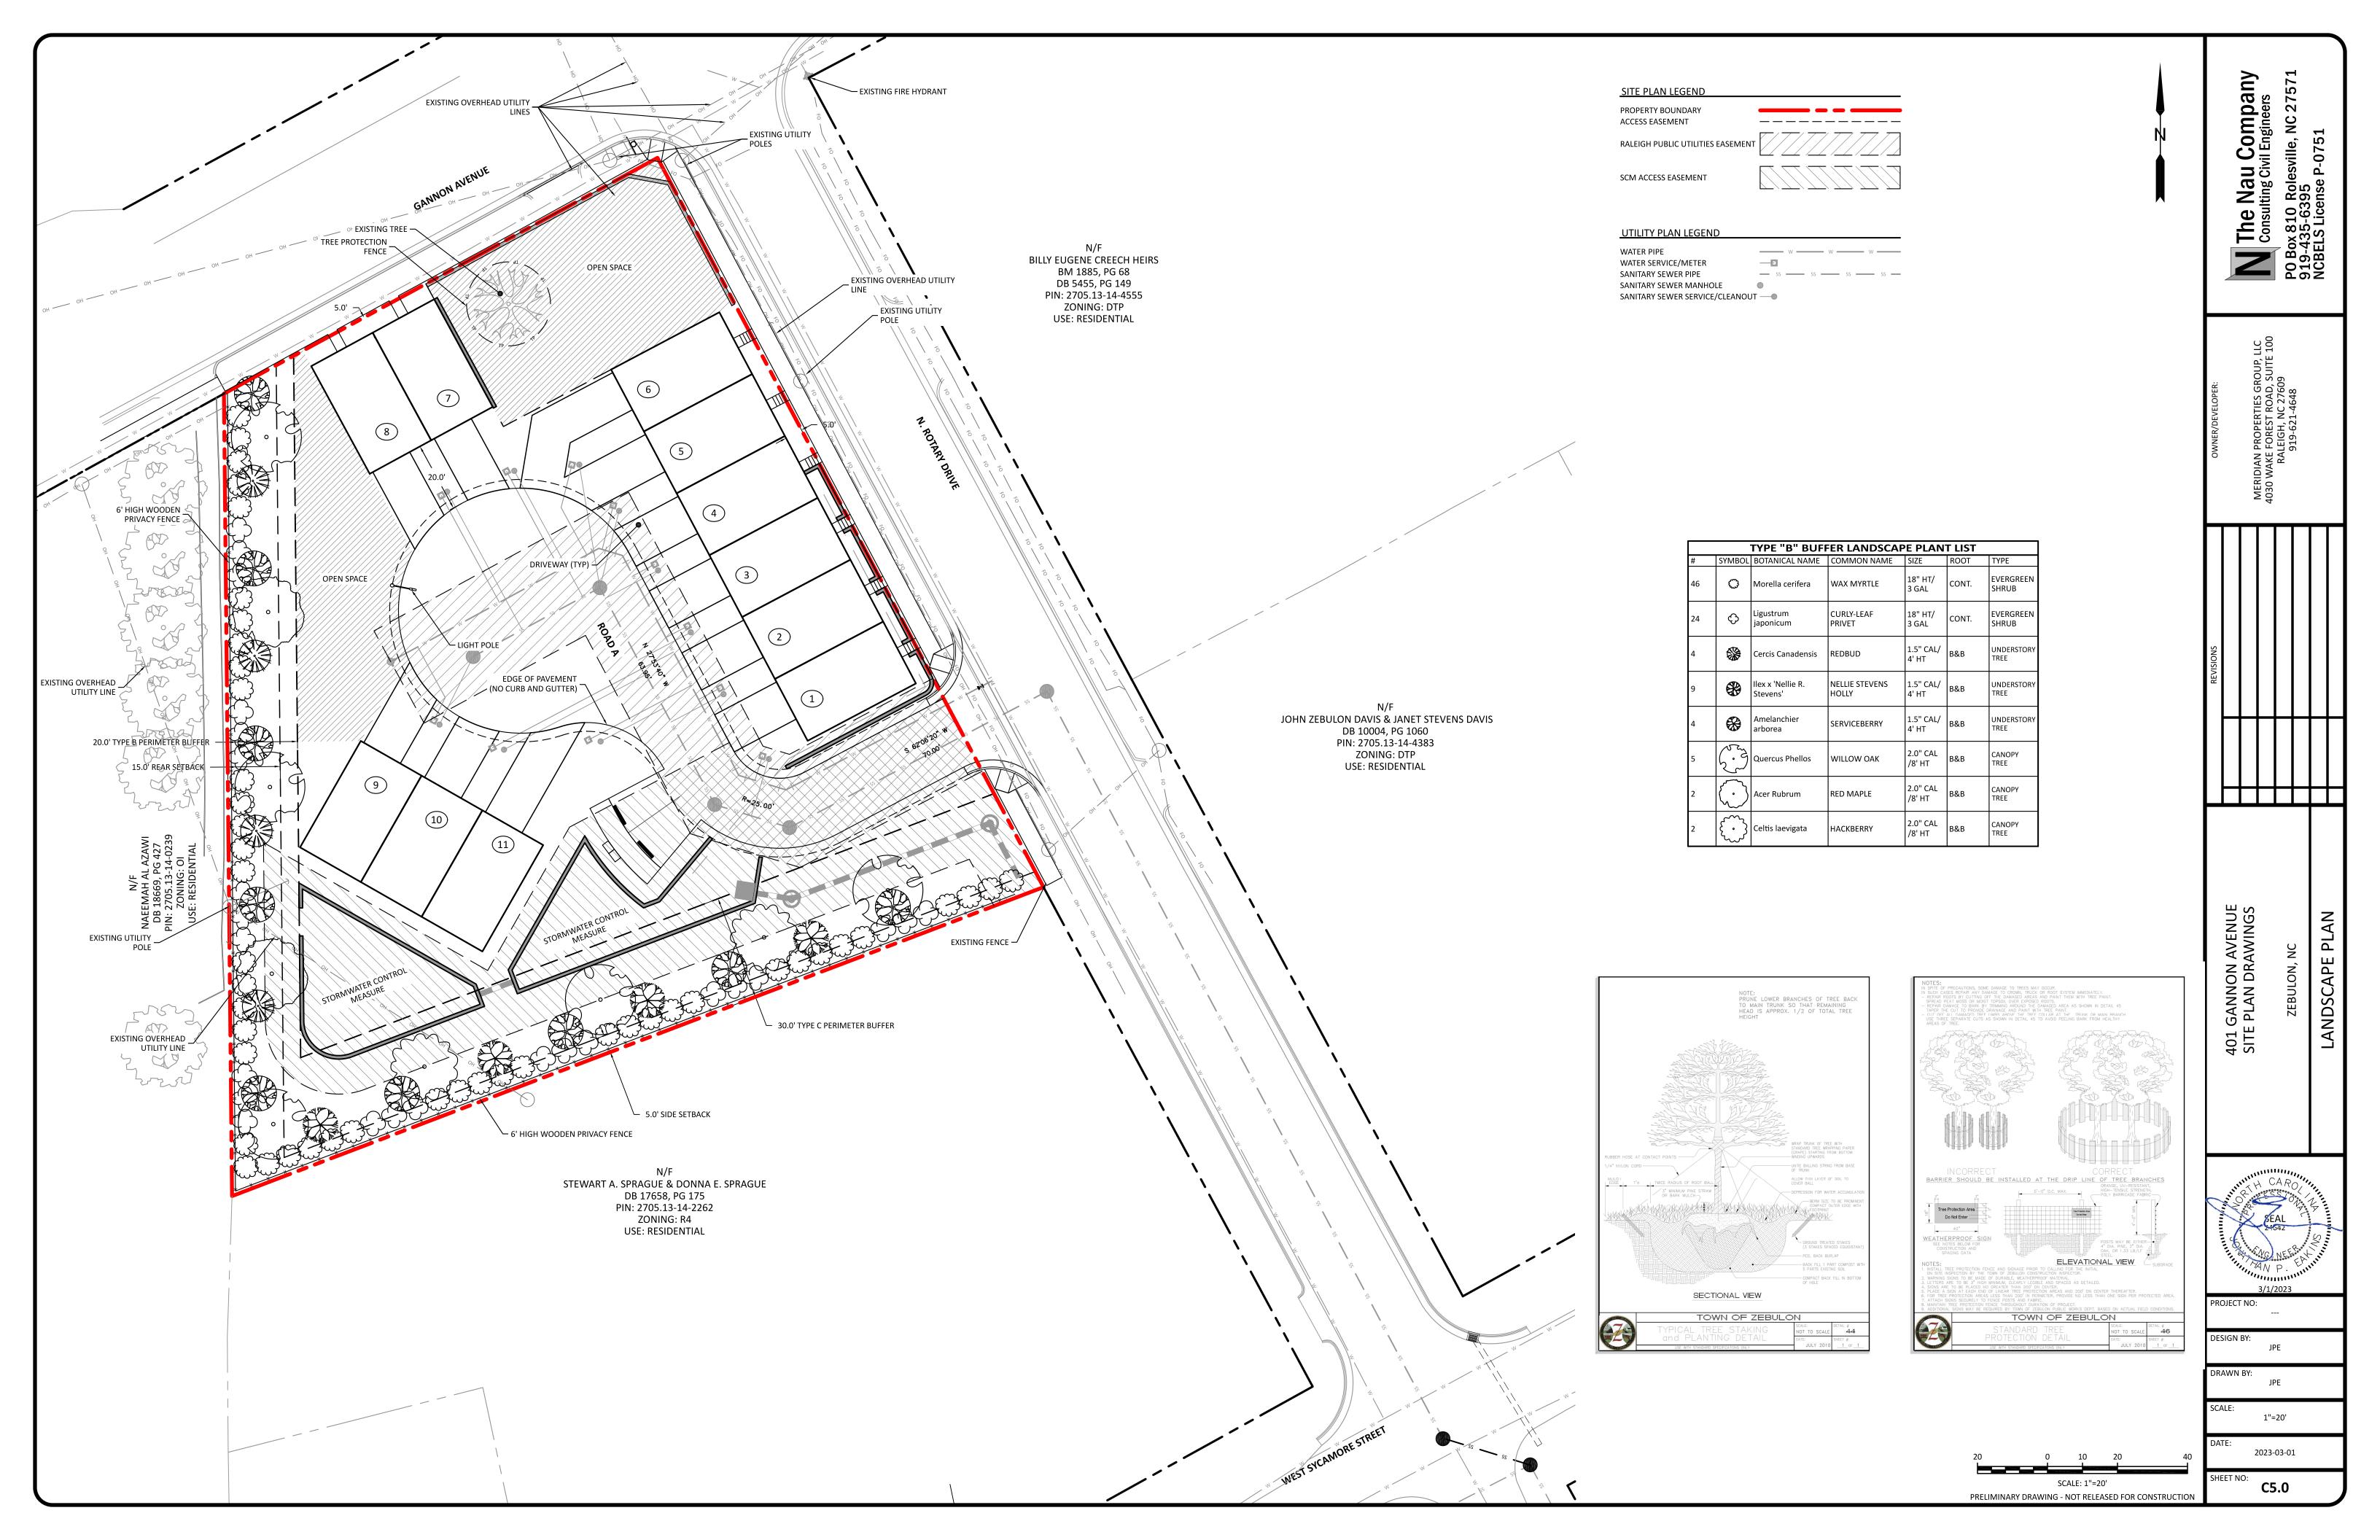


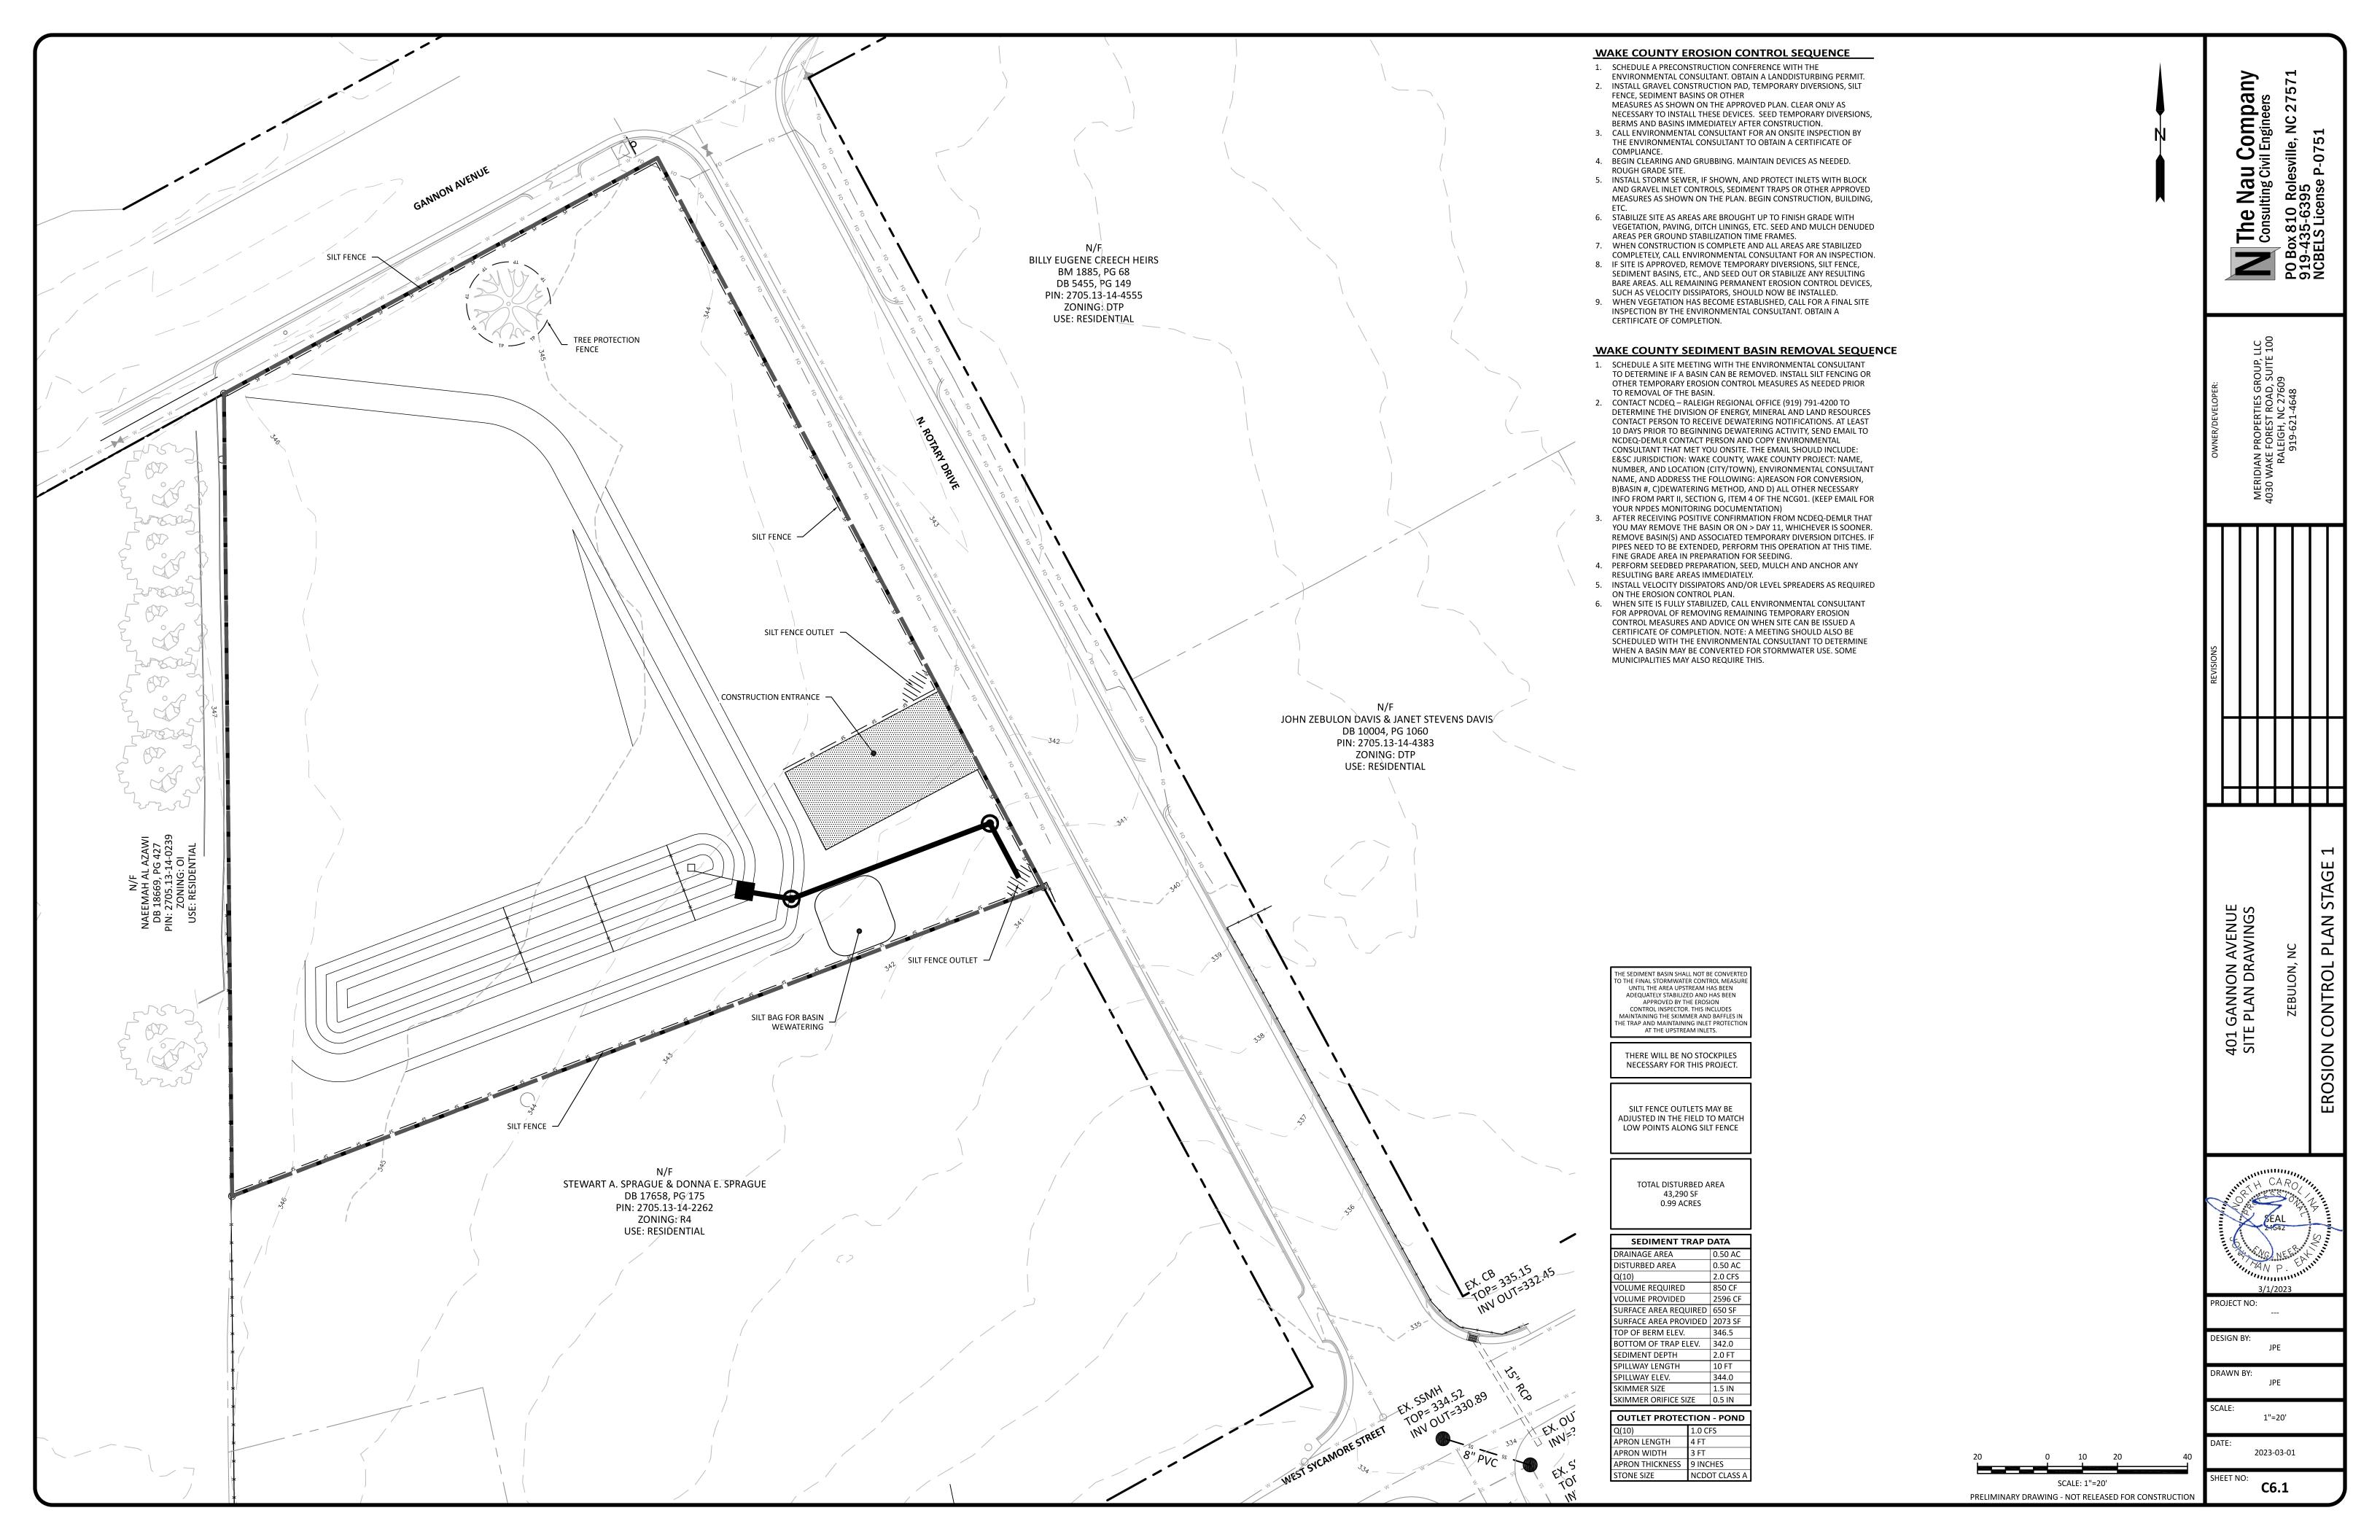


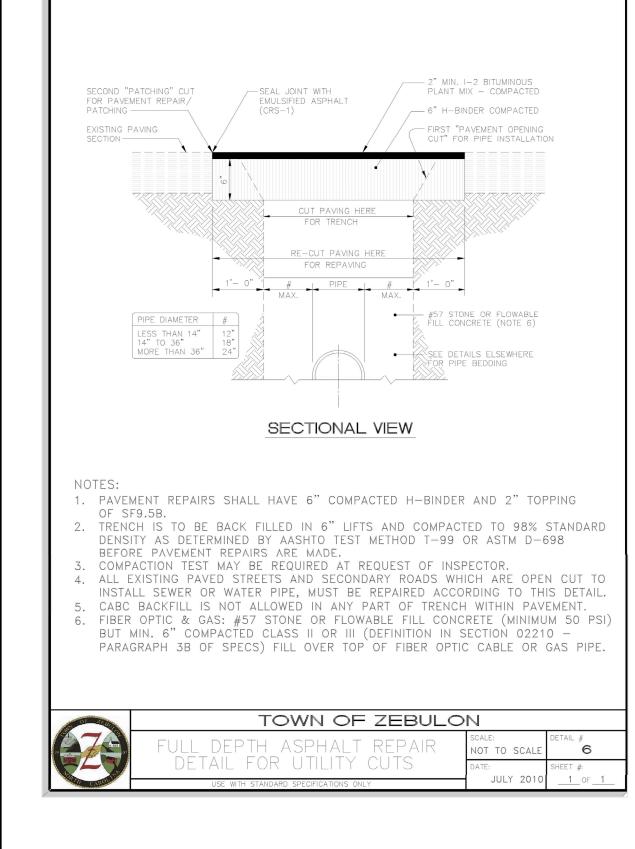


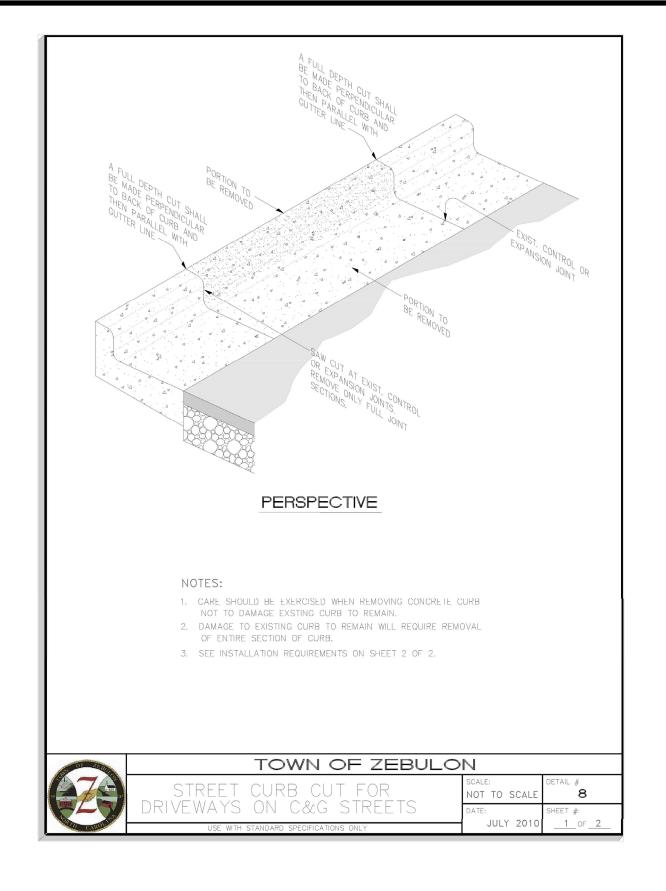


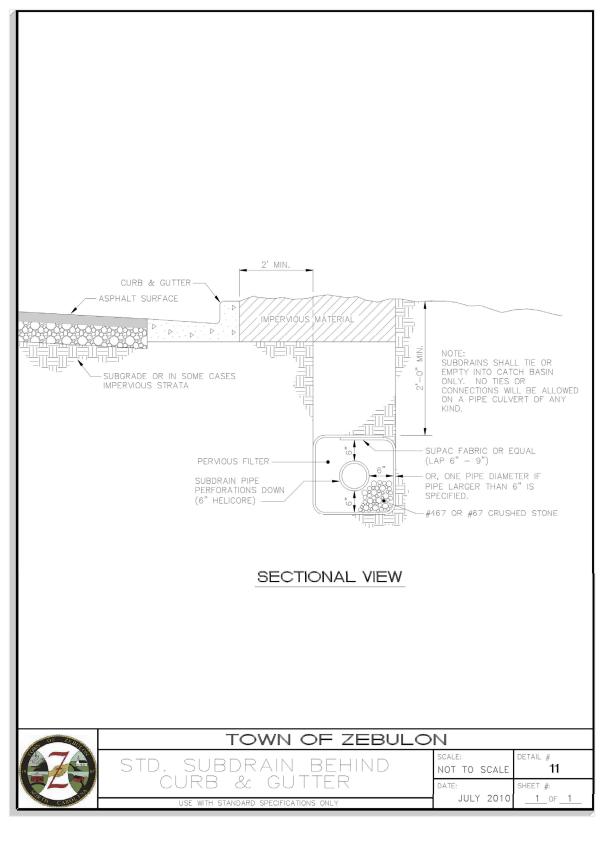


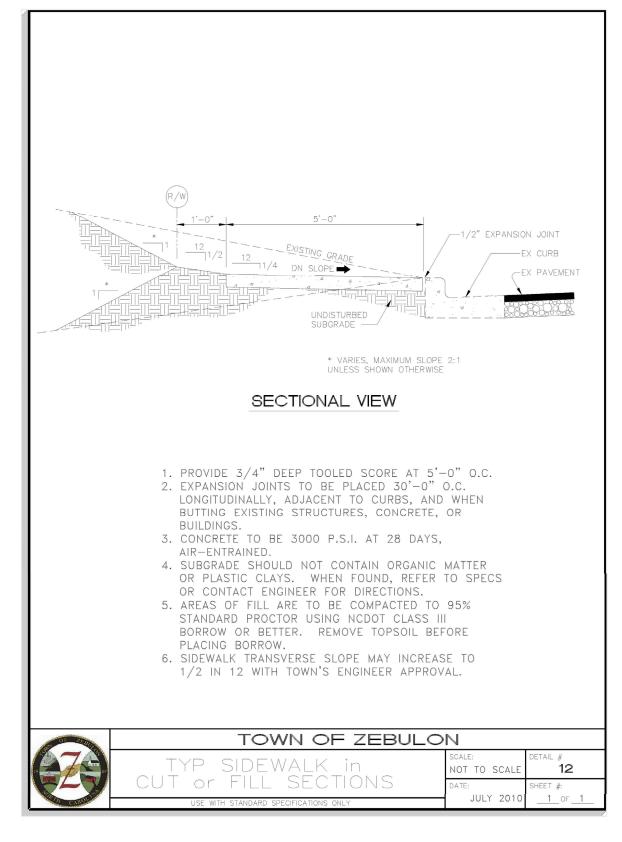

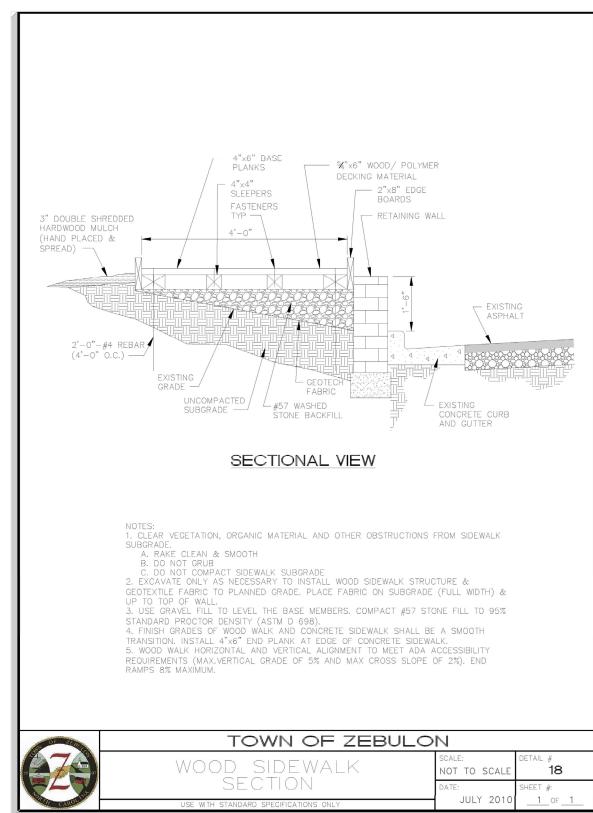

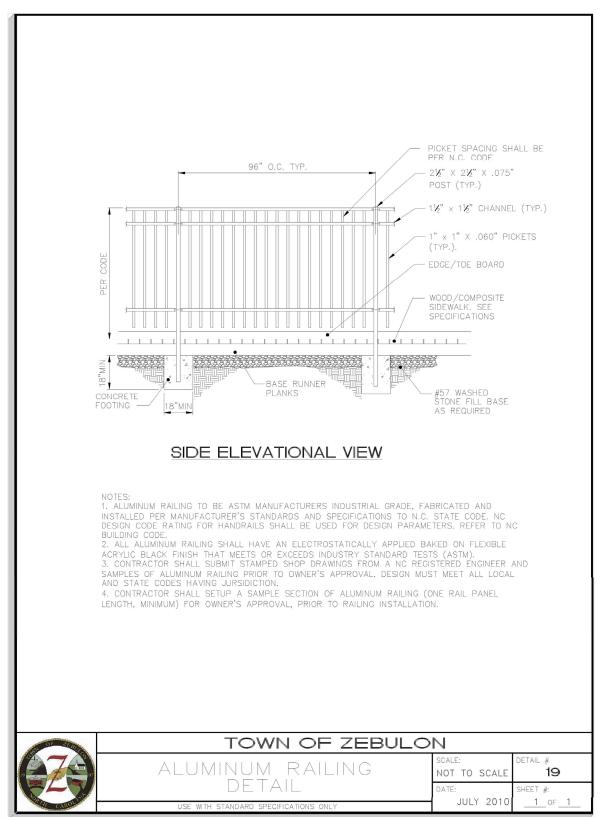

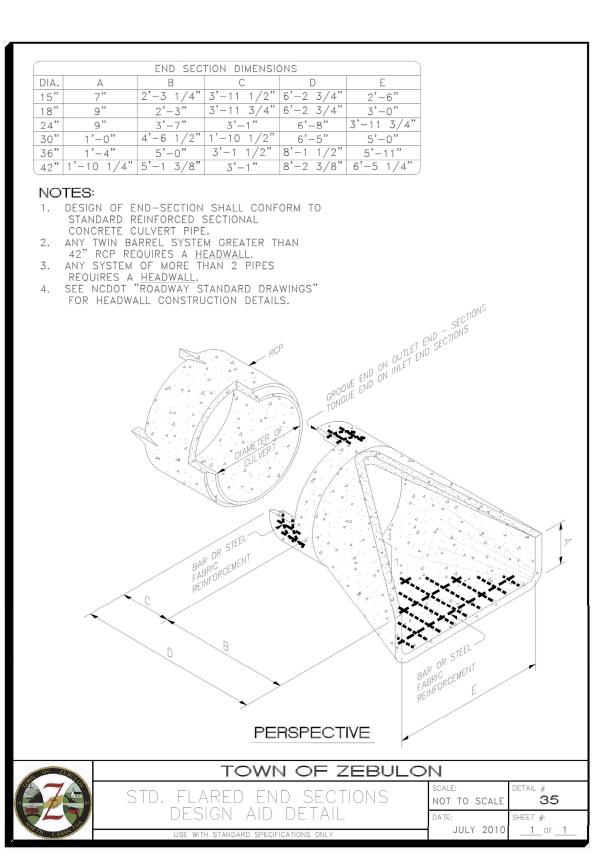

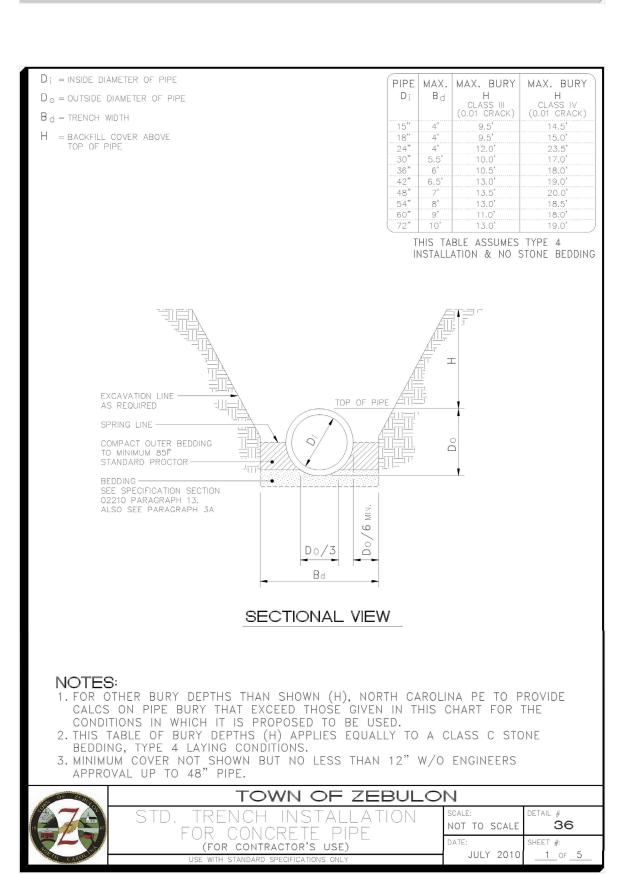



Company vil Engineers


Nau (

The Consul


30x 810 | -435-639 ELS Lice

SHEET NO:

D1.1

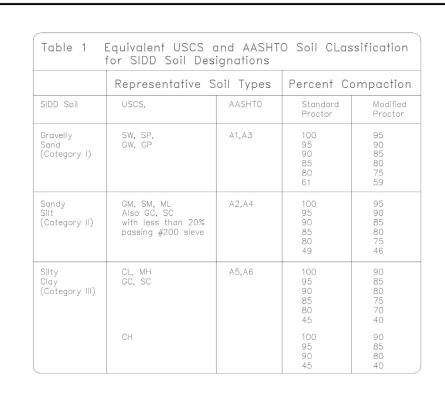

OF ZIBID	TOWN OF ZEBULO	Ν	
47	STD. TRENCH INSTALLATION	SCALE: NOT TO SCALE	DETAIL
TO AROUND	(TRENCH CONDITION SHOWN) USE WITH STANDARD SPECIFICATIONS ONLY	DATE: JULY 2010	SHEET

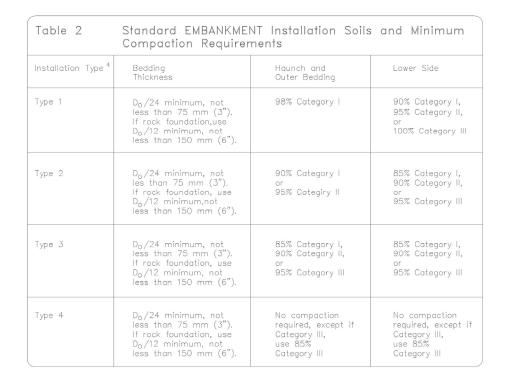


Notes:


36


- Compaction and soils symbols i.e. "98% Category 1' refers to Category 1 soil material with a minimum standard Proctor compaction of 98%. See Table 1 for equivalent modified Proctor values.
 Soil in the outer bedding, haunch, and lower side zones, except within D0/3 from
- Soil in the outer bedding, haunch, and lower side zones, except within D0/3 from the pipe springline, shall be compacted to at least the same compaction as the majority of the soil in the overfill zone.
 Subtrenches
- 3.1 A subtrench is defined as a trench with its top below finished grade by more than 0.1 H or, for roadways, its top is at an elevation lower than 0.3 m (1') below the bottom of the pavement base material.
- 3.2 The minimum width of a subtrench shall be 1.33 Do or wider if required for adequate space to attain the specified compaction in the haunch and bedding
- 3.3 For subtrenches with wall of natural soil, any portion of the lower side zone in the subtrench wall shall be at least as firm as an equivalent soil placed to the compaction requirements specified for the lower side zone and as firm as the majority of soil in the overfill zone, or shall be removed and replaced with soil compacted to the specified level.
- 4. Type 1 installation = relatively high quality material & high compaction effort.


 Type 4 installation = little or no control over material and compaction.

OF THEIR	TOWN OF ZEBULON SCALE: DETAIL #			
279	STD. TRENCH INSTALLATION	SCALE: NOT TO SCALE	36	
ALCOUNTY CAROLINA	(IRENCH CONDITION SHOWN) USE WITH STANDARD SPECIFICATIONS ONLY	DATE: JULY 2010	SHEET #: 4_ OF5	

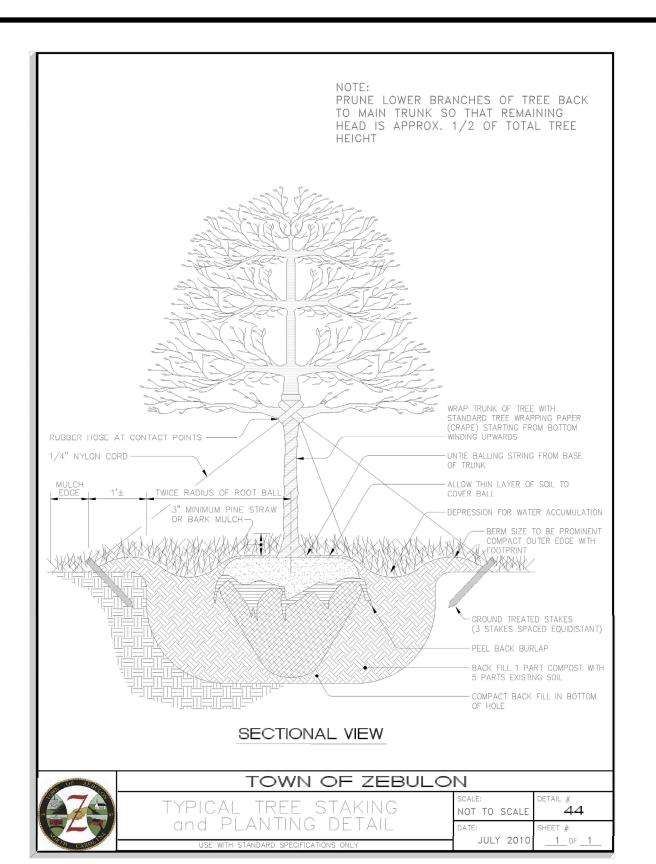

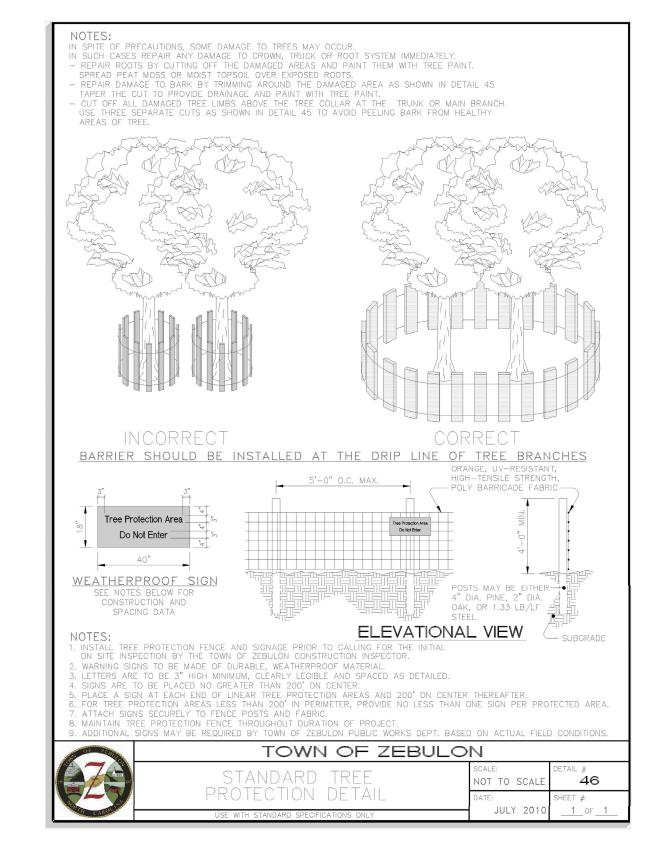

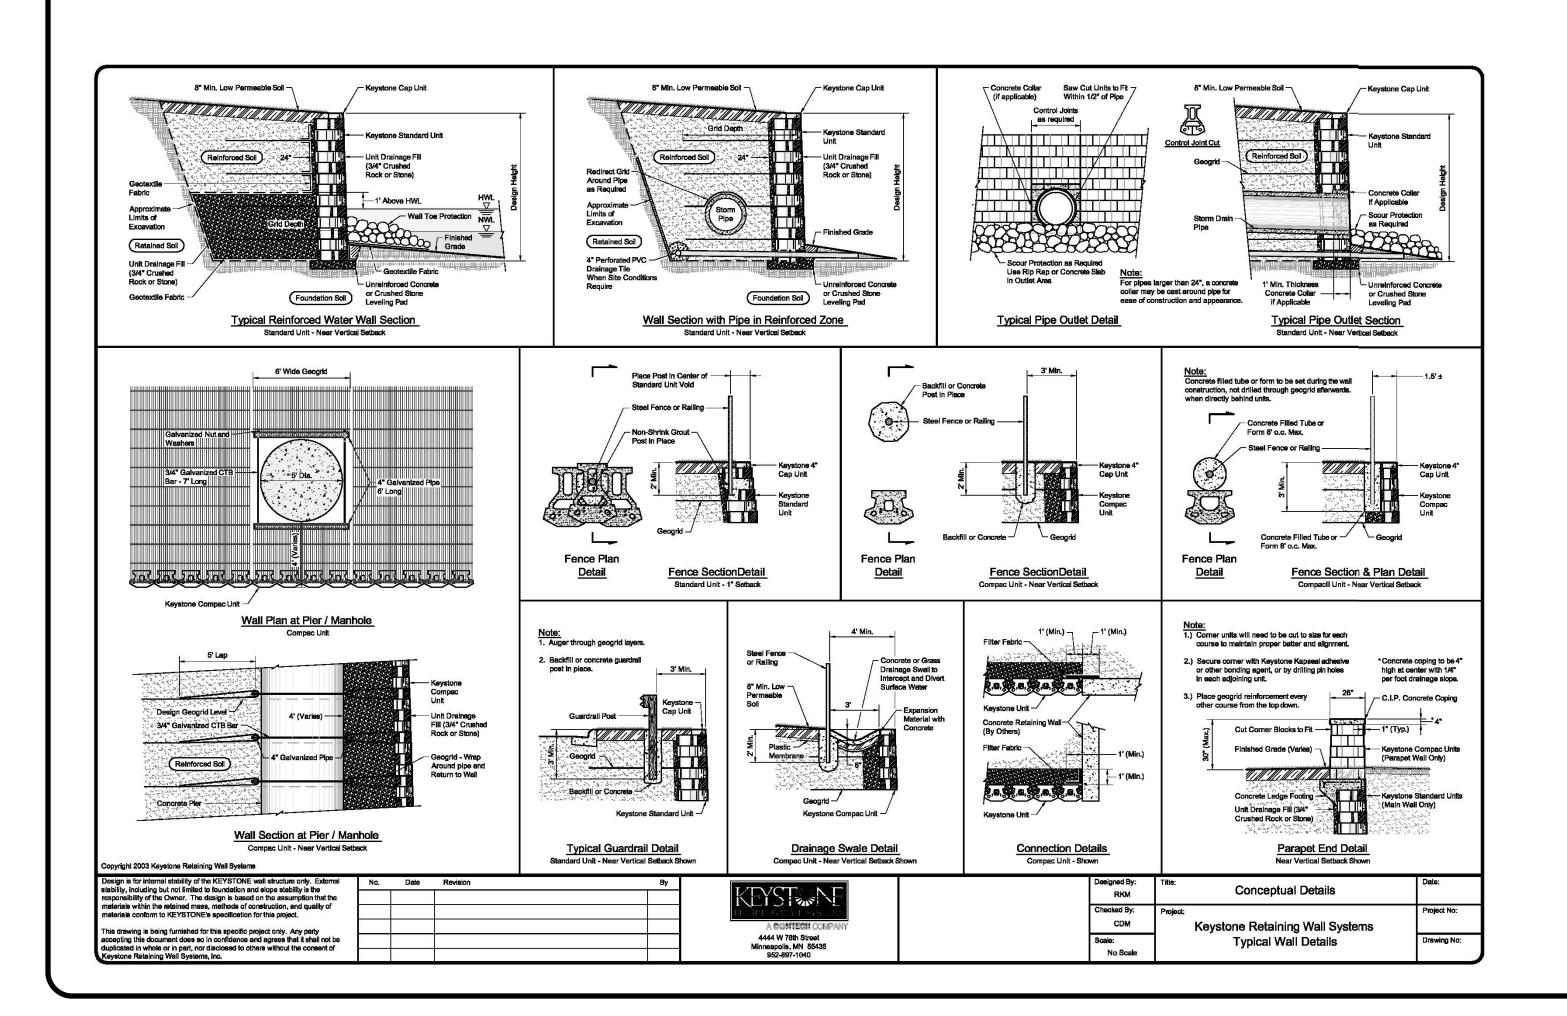

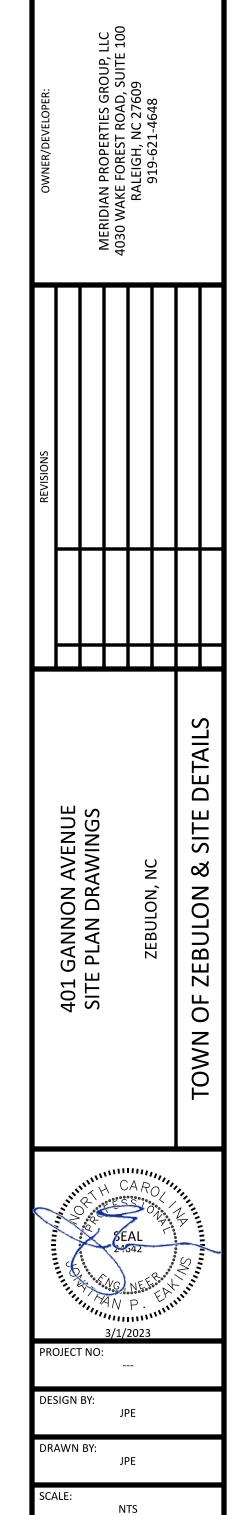



2023-03-01


Nau Company Iting Civil Engineers


The Consul 27


30x 81 -435-6 ELS Li

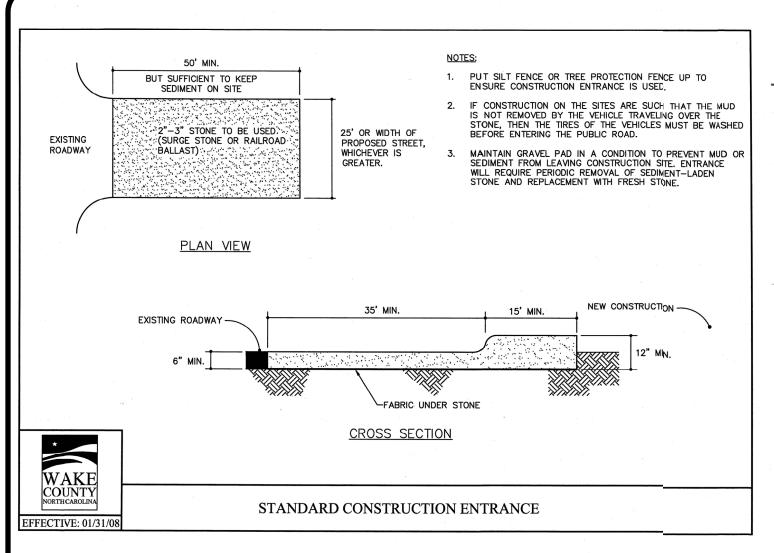


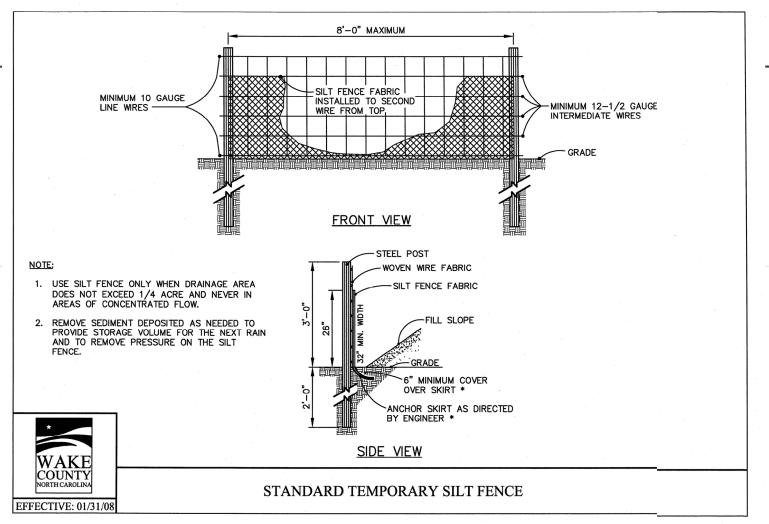


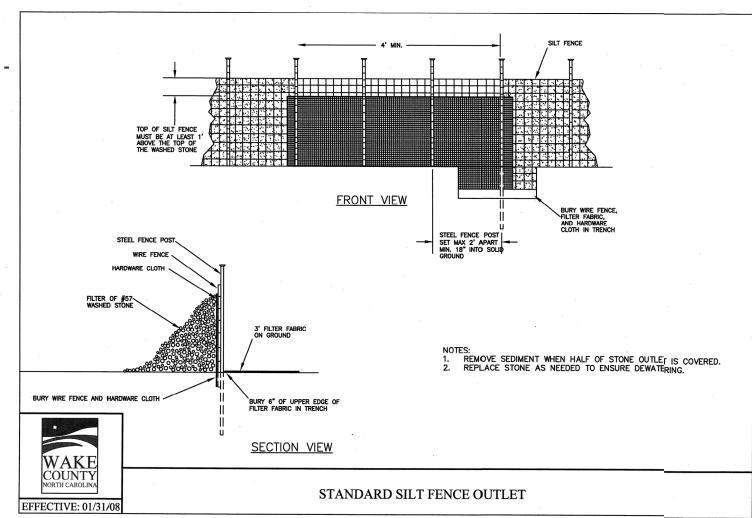


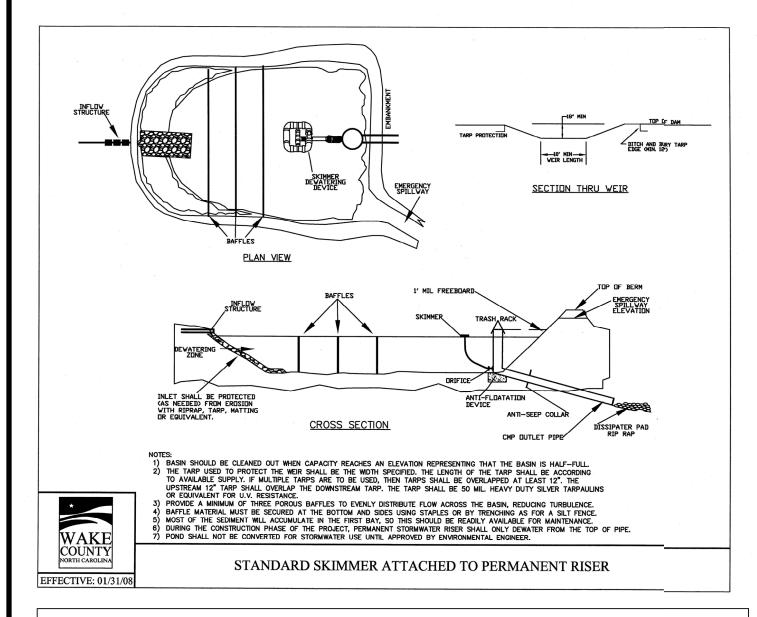


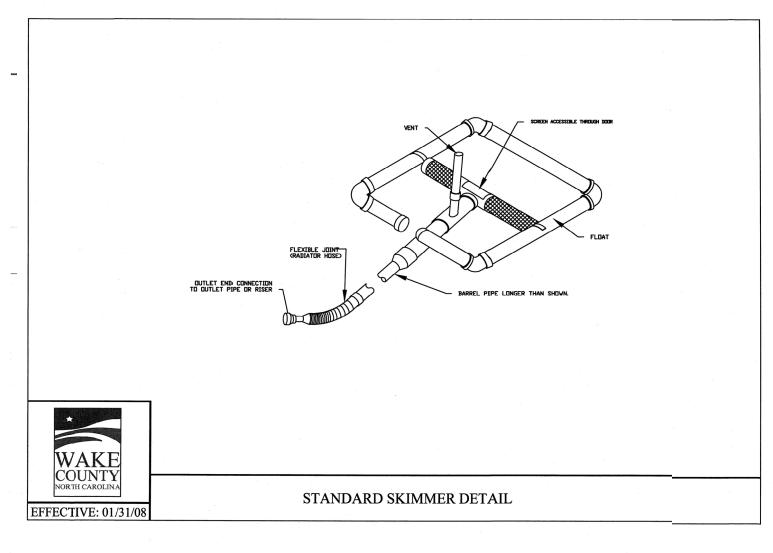


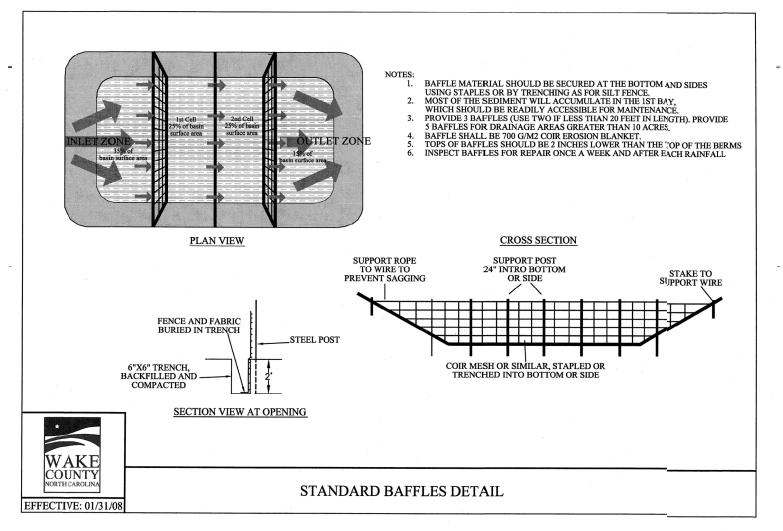

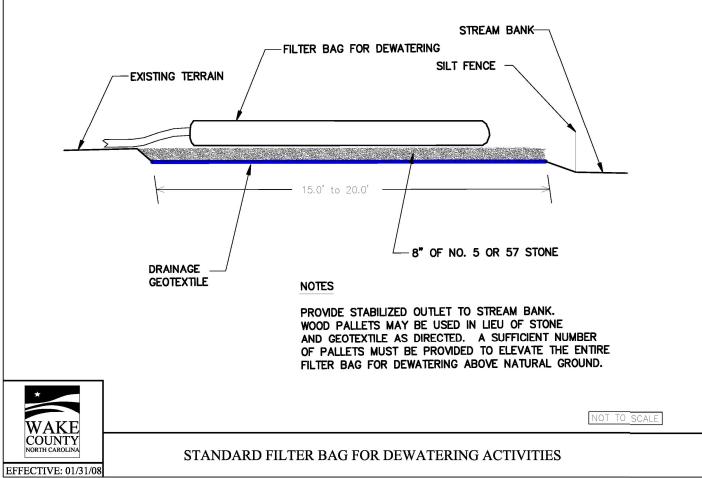

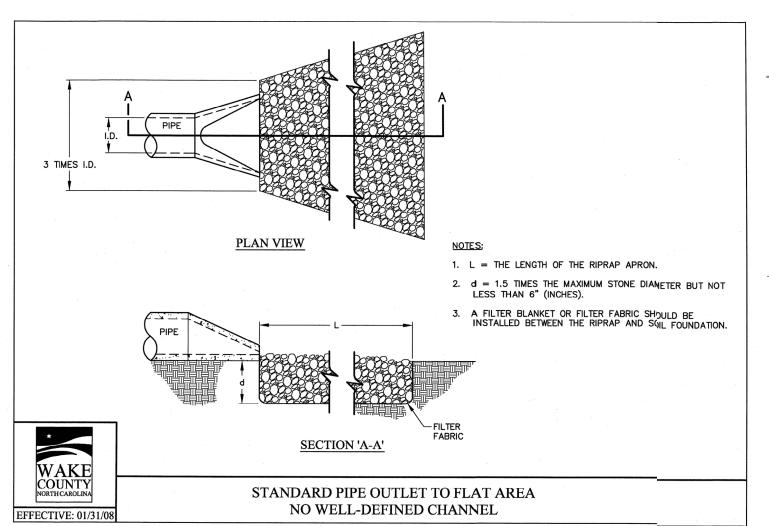

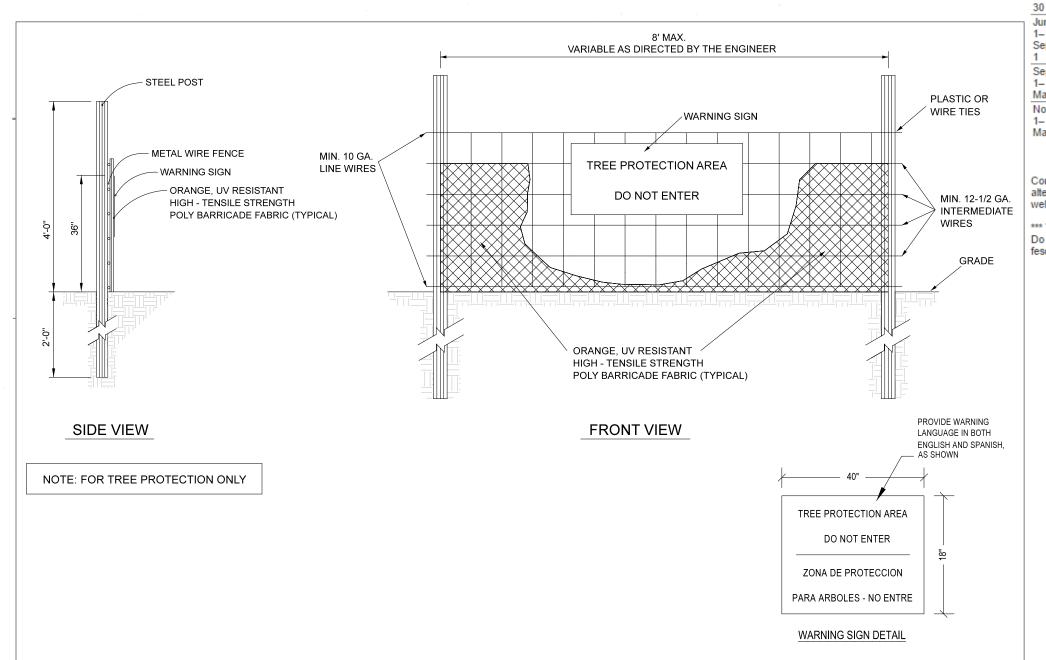

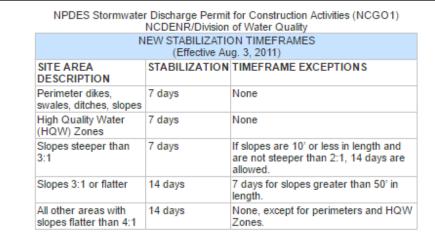

Seedbed Preparation:

- 1. Chisel compacted areas and spread topsoil three inches deep over adverse soil conditions, if available.
- Rip the entire area to six inches deep. 3. Remove all loose rock, roots and other obstructions, leaving surface reasonably
- smooth and uniform. Apply agricultural lime, fertilizer and superphosphate uniformly and mix with soil (see mixture below)
- Continue tillage until a well-pulverized, firm, reasonably uniform seedbed is prepare four to six inches deep.
- 6. Seed on a freshly prepared seedbed and cover seed lightly with seeding equipment or cultipack after seeding.
- 7. Mulch immediately after seeding and anchor mulch. 8. Inspect all seeded areas and make necessary repairs or reseedings within the planting season, if possible. If stand should be more than 60% damaged, re-establish
- following the original lime, fertilizer and seeding rates.
- Consult S&EC Environmental Engineers on maintenance treatment and fertilization after permanent cover is established.

Agricultural Limestone	2 tons/acre (3 tons/acre in clay soils)
Fertilizer	1,000 lbs/acre - 10-10-10
Superphosphate	500 lbs/acre - 20% analysis
Mulch	2 tons/acre – small grain straw
Anchor	Asphalt emulsion at 300 gals/acre

Seding Schedule

For Shoulders, Side Ditches, Slopes (Max 3:1):

Date	Туре	Planting Rate
Aug 15– Nov 1	Tall Fescue	300 lbs/acre
Nov 1–Mar 1	Tall Fescue & Abruzzi Rye	300 lbs/acre
Mar 1–Apr 15	Tall Fescue	300 lbs/acre
Apr 15– Jun 30	Hulled Common Bermudagrass	25 lbs/acre
Jul 1– Aug 15	Tall Fescue AND Browntop Millet or Sorghum-Sudan Hybrids***	125 lbs/acre (Tall Fescue); 35 lbs/acre (Browntop Millet); 30 lbs/acre (Sorghum- Sudan Hybrids)

For Shoulders, Side Ditches, Slopes (3:1 to 2:1):

Date	Туре	Planting Rate
Mar 1–Jun 1	Sericea Lespedeza (scarified) and use the following combinations:	50 lbs/acre (Sericea Lespedeza);
Mar 1–Apr 15	Add Tall Fescue	120 lbs/acre
Mar 1–Jun 30	Or add Weeping Love grass	10 lbs/acre
Mar 1–Jun 30	Or add Hulled Common Bermudagrass	25 lbs/acre
Jun 1– Sept 1	Tall Fescue AND Browntop Mullet or Sorghum-Sudan Hybrids***	120 lbs/acre (Tall Fescue); 35 lbs/acre (Browntop Mullet); 30 lbs/acre (Sorghum- Sudan Hybrids)
Sept 1– Mar 1	Sericea Lespedeza (unhulled – unscarified) AND Tall Fescue	70 lbs/acre (Sericea Lespedeza); 120 lbs/acre (Tall Fescue)
Nov 1– Mar 1	AND Abruzzi Rye	25 lbs/acre

Consult S&EC Environmental Engineers for additional information concerning other alternatives for vegetation of denuded areas. The above vegetation rates are those that do well under local conditions; other seeding rate combinations are possible.

** TEMPORARY: Reseed according to optimum season for desired permanent vegetation Do not allow temporary cover to grow more than 12" in height before mowing; otherwise, fescue may be shaded out.

Nau Iting Civ The Consu ∞ Ω

Company vil Engineers

27

GANNON AVENUE PLAN DRAWINGS


CONTROL EROSION


DESIGN BY: JPE


DRAWN BY: JPE SCALE: NTS


2023-03-01


D2.1 PRELIMINARY DRAWING - NOT RELEASED FOR CONSTRUCTION

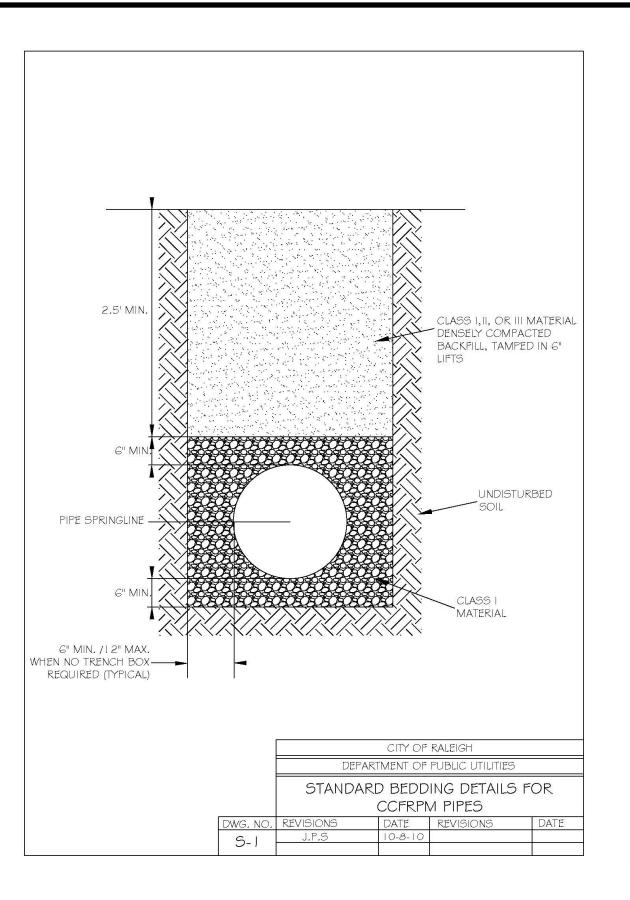


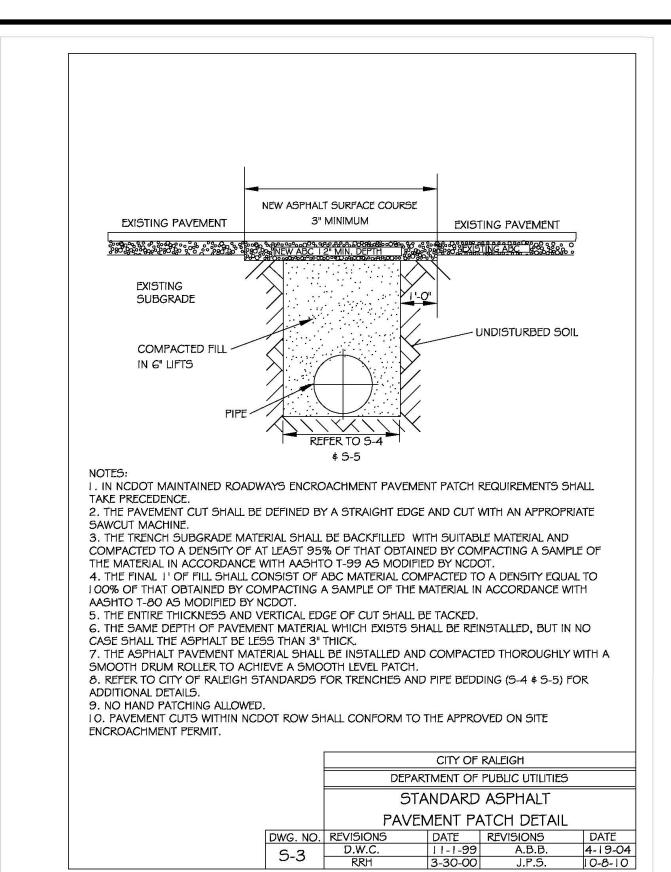


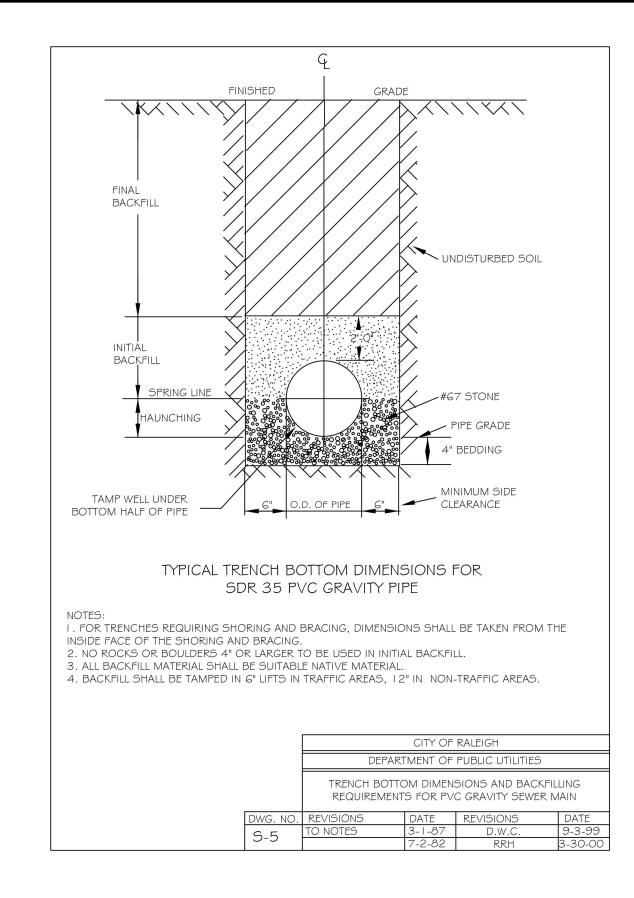


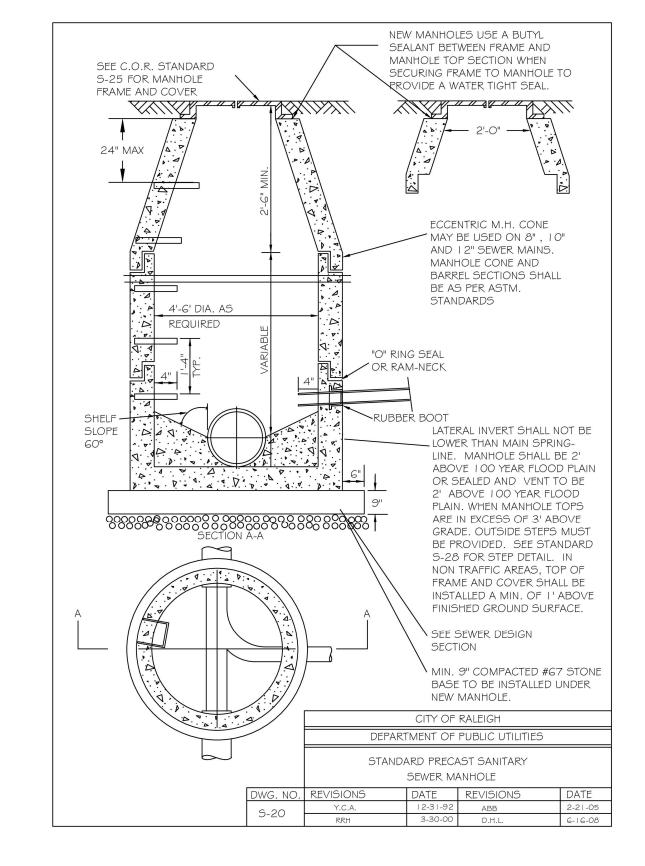


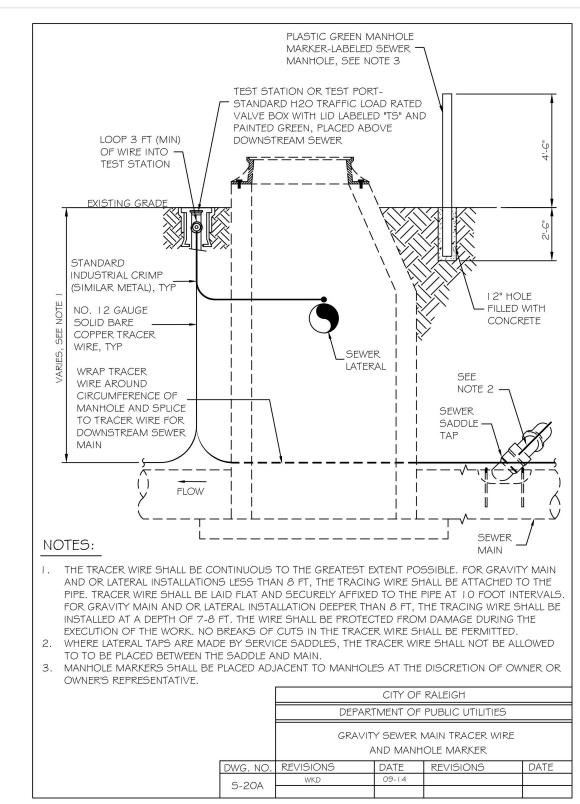

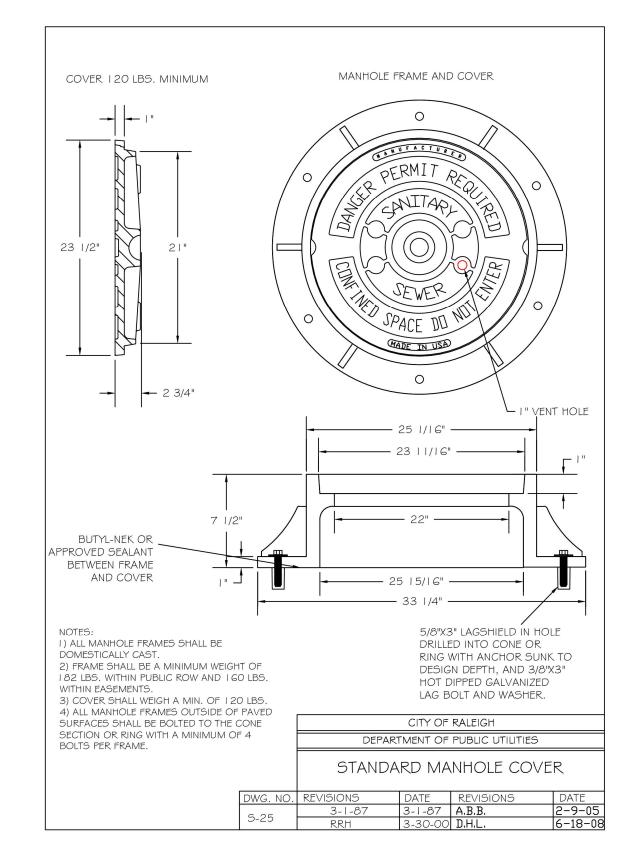


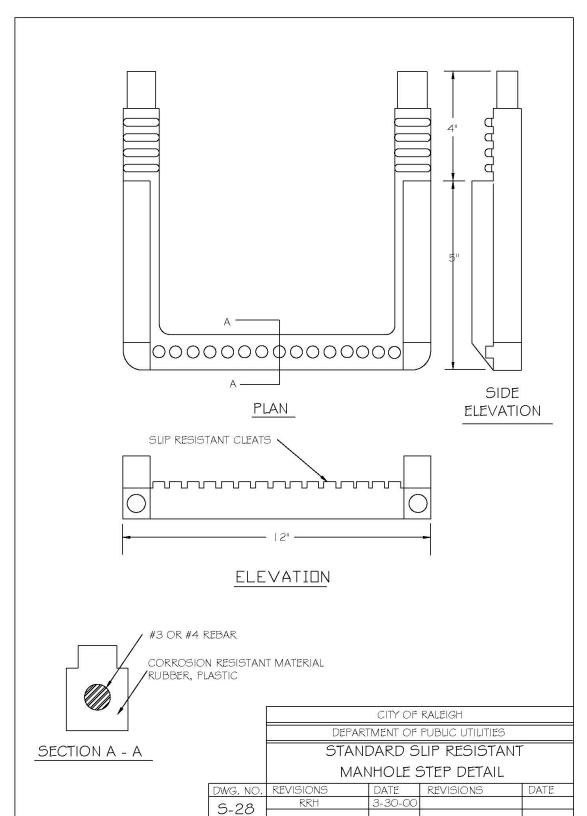


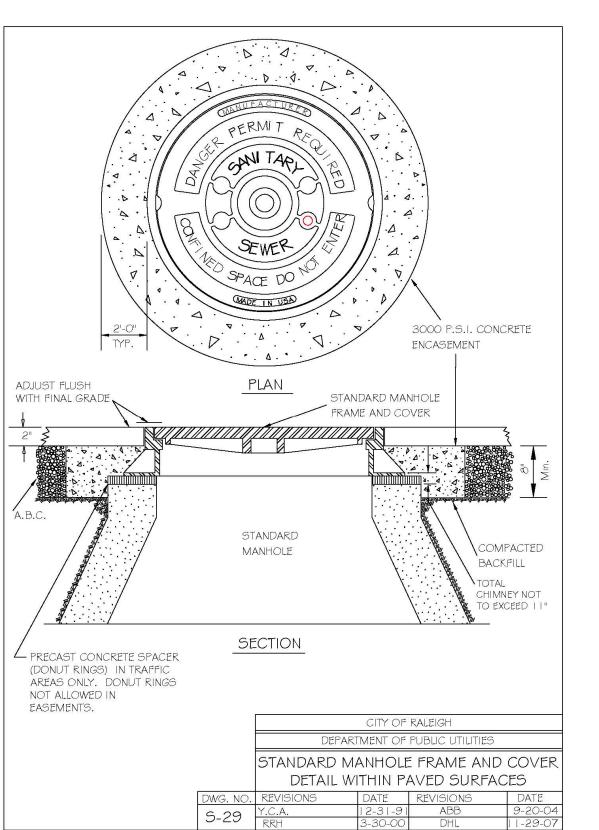


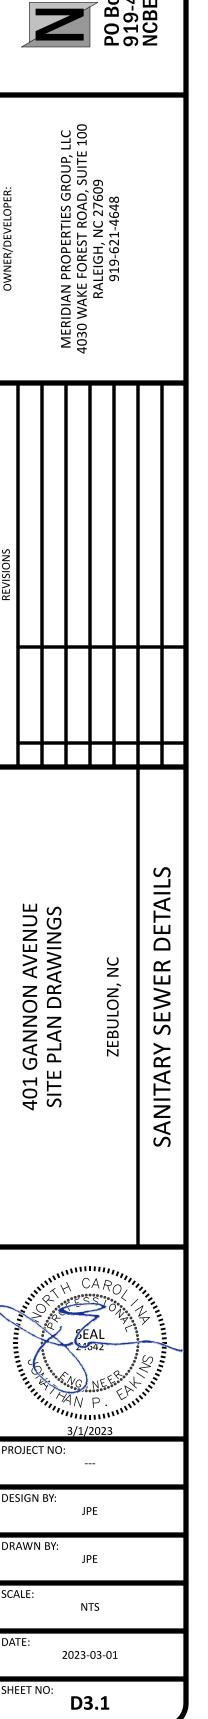



Nau Iting Civ

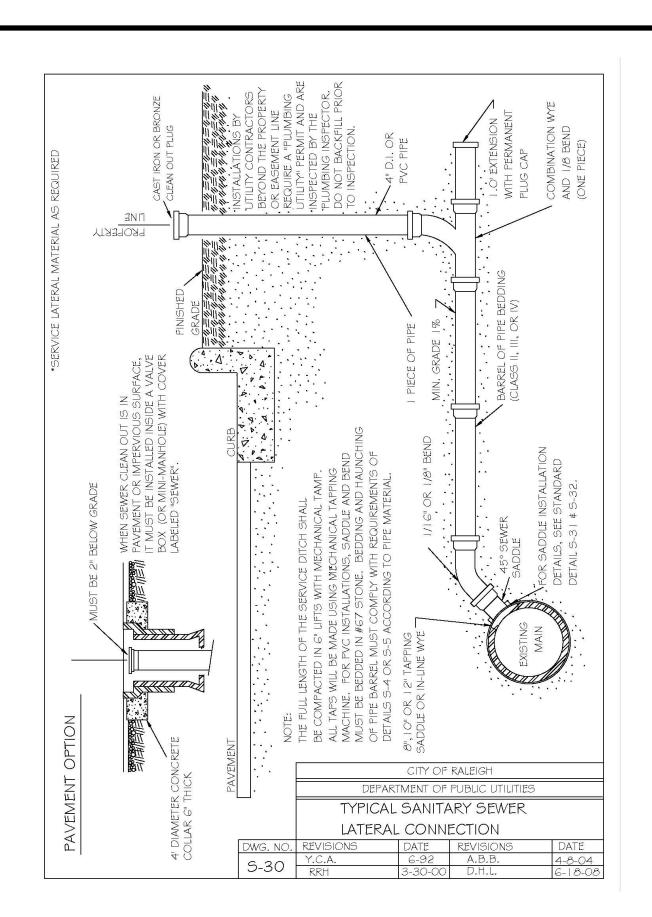

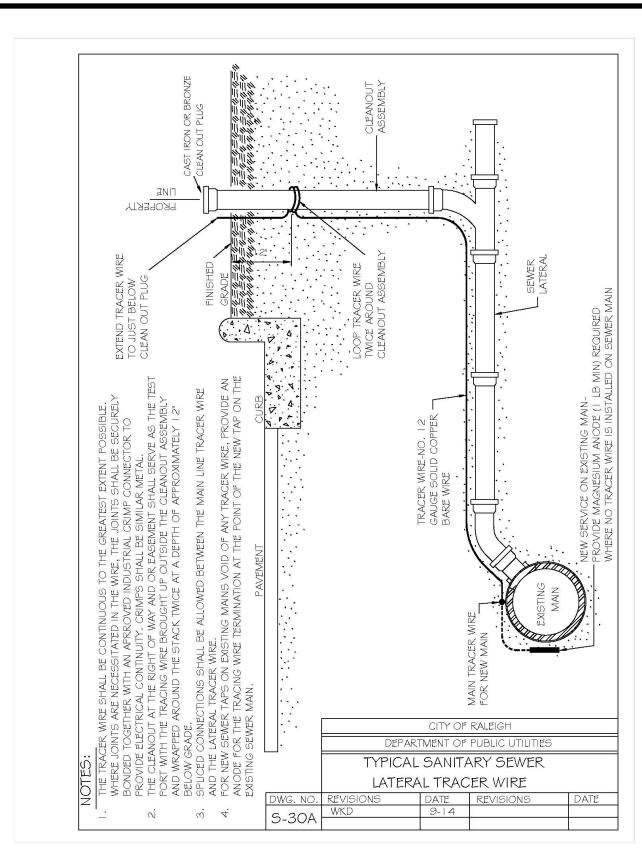

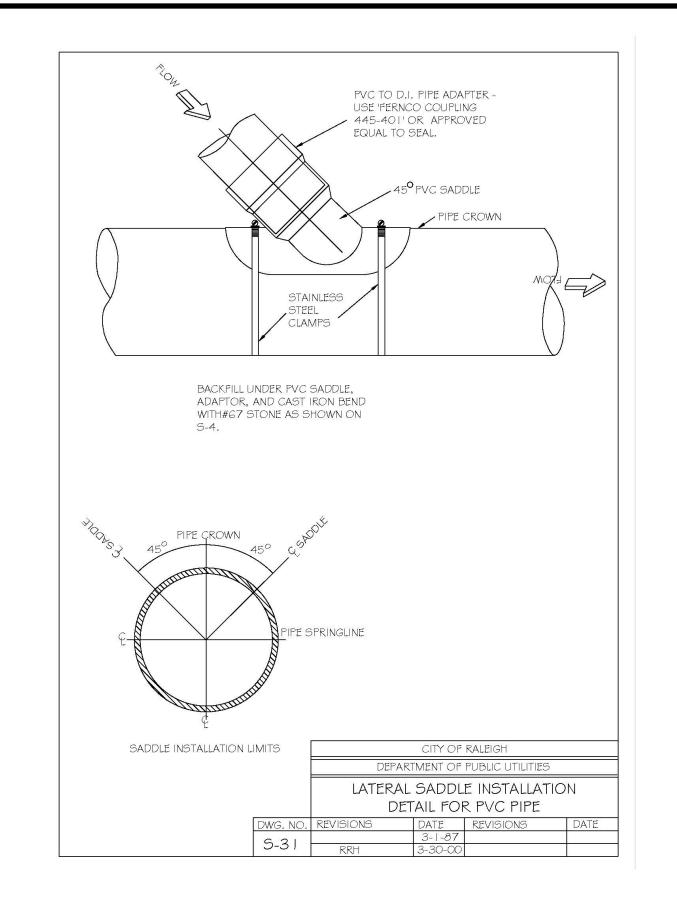


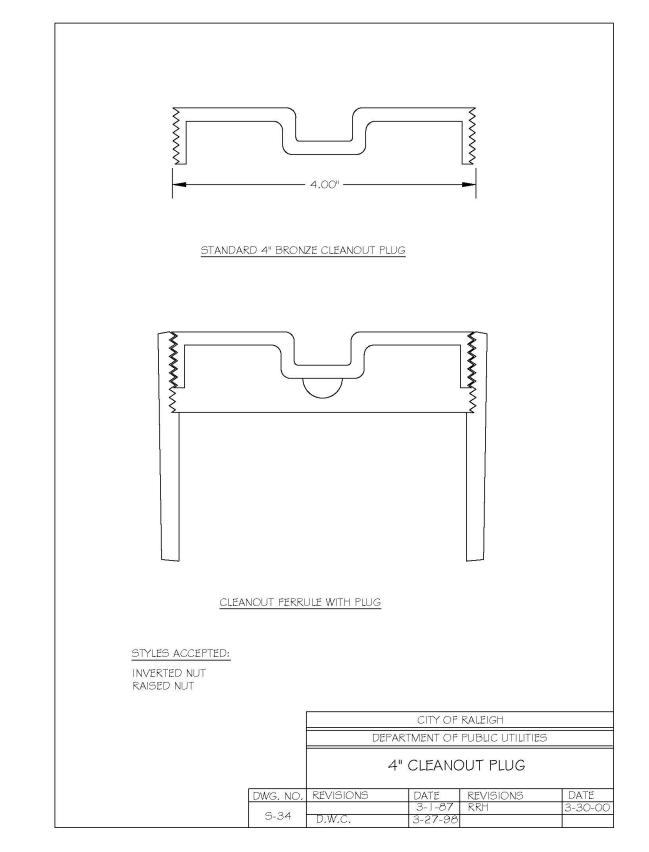


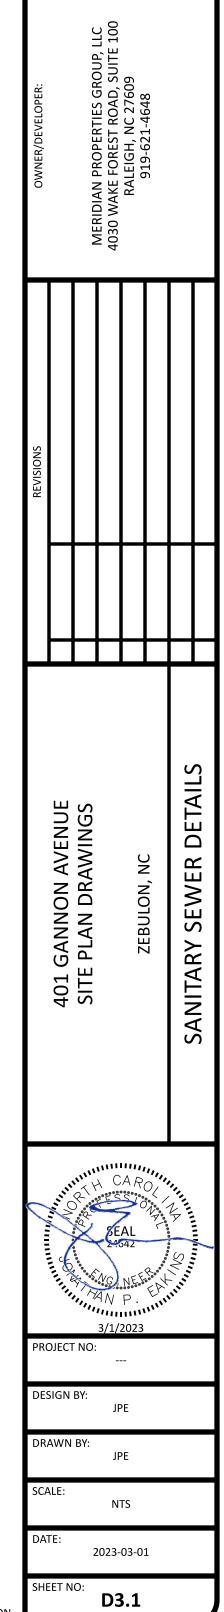



ille, NC 27571

The Nau Company Consulting Civil Engineers

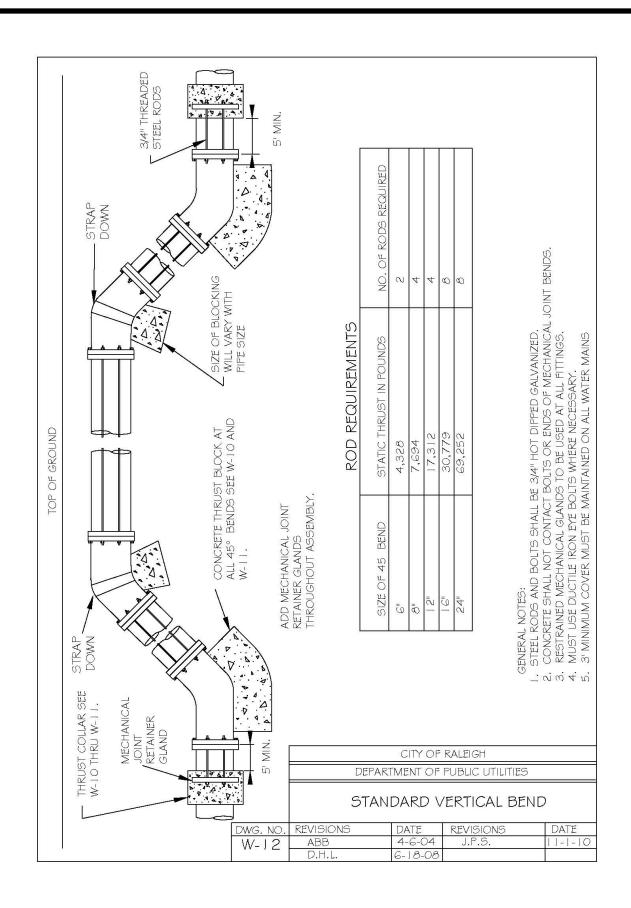

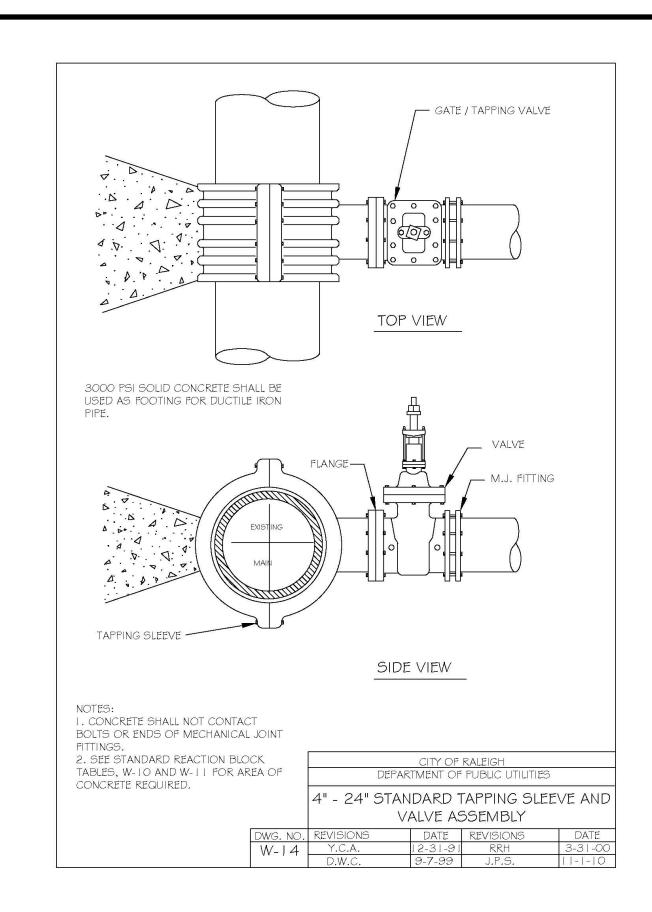


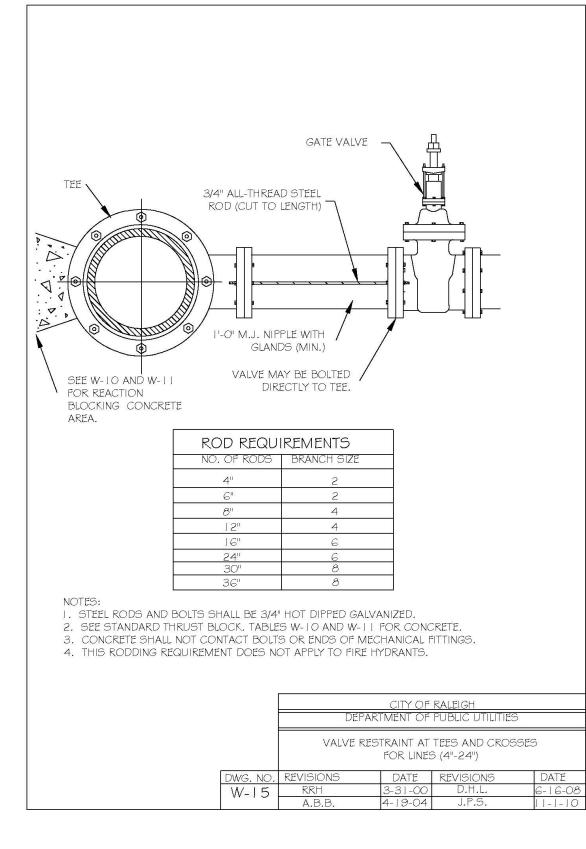


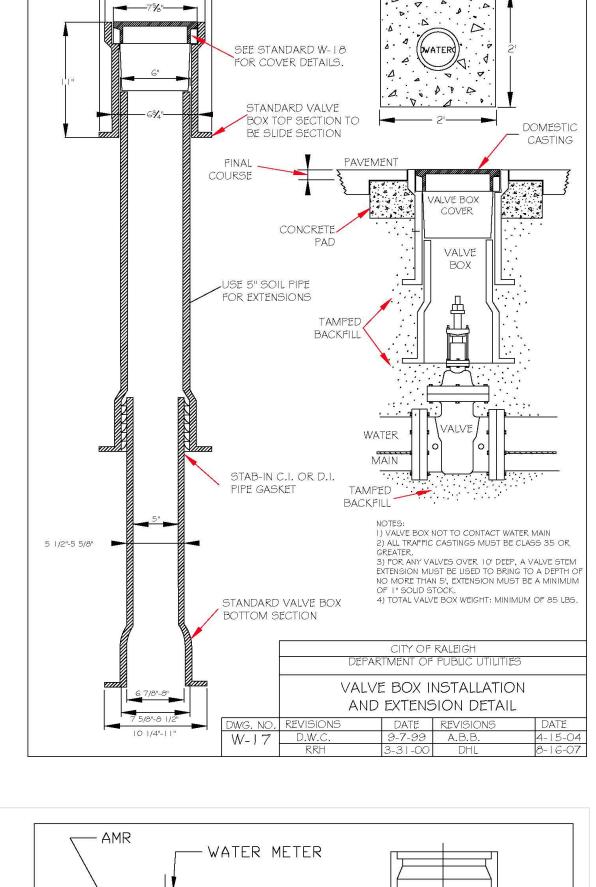



APPROVED METHOD FOR EXTENSION OF VALVE BOX


NOTE: 2'x 2'x 6" CONCRETE PAD REQUIRED ON ALL VALVES. NO PRECAST CONCRETE DOUGHNUT ALLOWED.

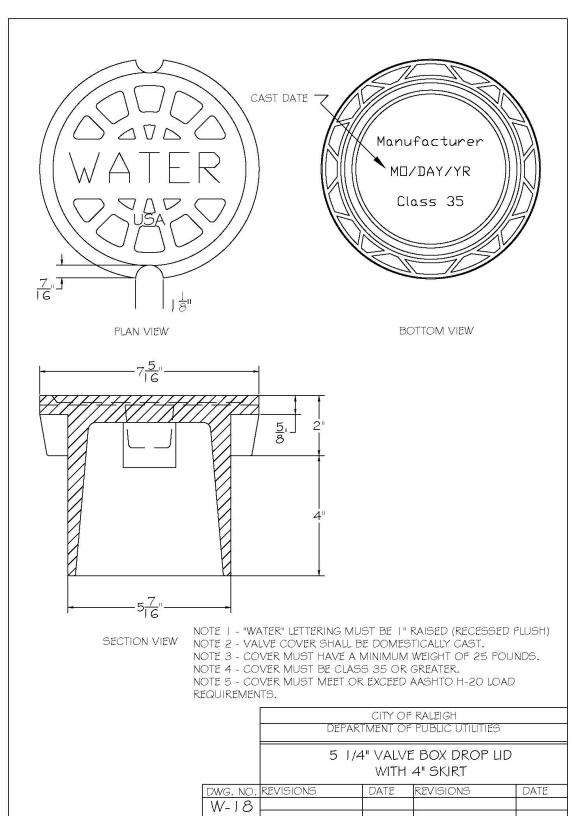

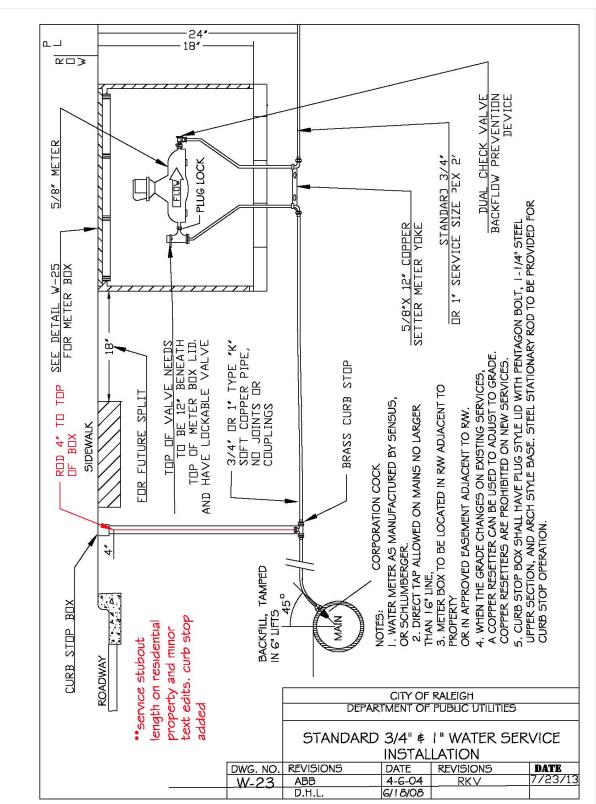

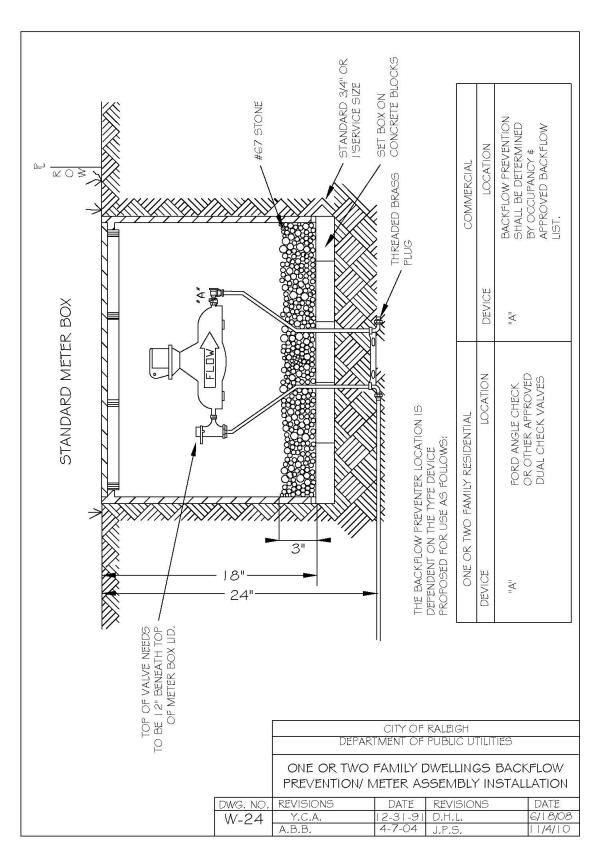

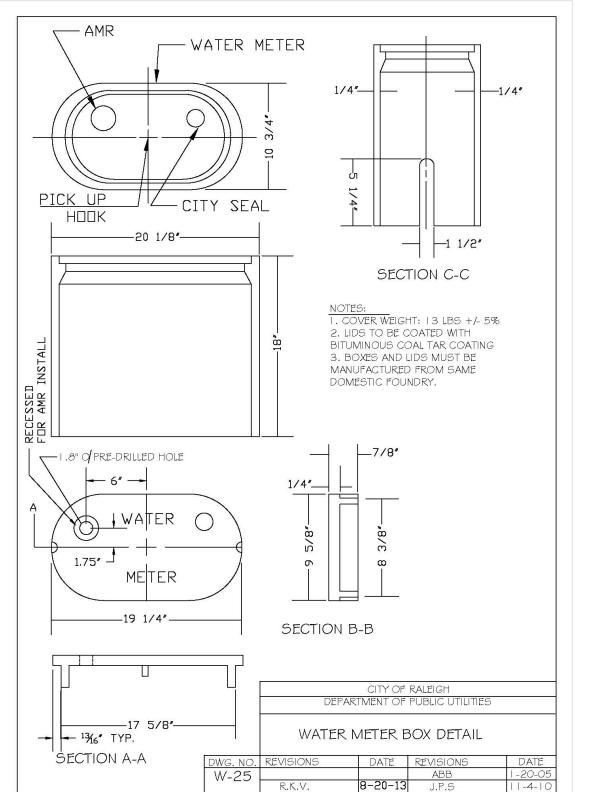


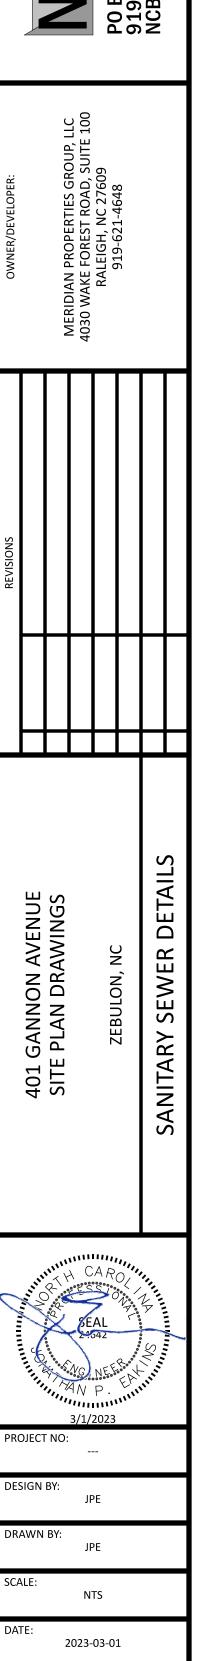

D3.1

PRELIMINARY DRAWING - NOT RELEASED FOR CONSTRUCTION


The Nau Company Consulting Civil Engineers

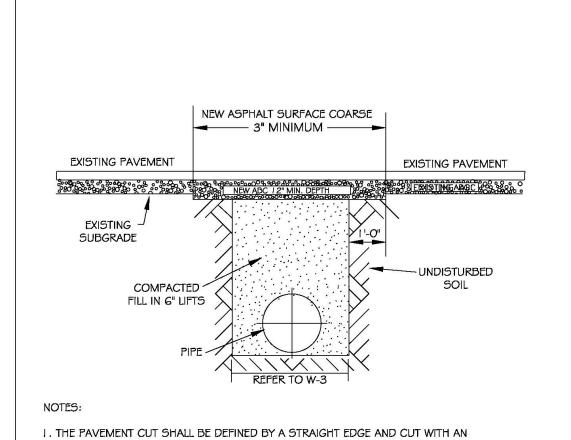



- . THE PAVEMENT CUT SHALL BE DEFINED BY A STRAIGHT EDGE AND CUT WITH AN APPROPRIATE SAW CUT MACHINE.
- 2. THE TRENCH SUBGRADE MATERIAL SHALL BE BACKFILLED WITH SUITABLE MATERIAL AND COMPACTED TO A DENSITY OF AT LEAST 95% OF THAT OBTAINED BY COMPACTING A SAMPLE OF THE MATERIAL IN ACCORDANCE WITH AASHTO T-99 AS MODIFIED BY NCDOT.
- 3. THE FINAL I' OF FILL SHALL CONSIST OF ABC MATERIAL COMPACTED TO A DENSITY EQUAL TO 100% OF THAT OBTAINED BY COMPACTING A SAMPLE OF THE MATERIAL IN
- ACCORDANCE WITH AASHTO T-80 AS MODIFIED BY NCDOT.


 4. THE ENTIRE THICKNESS/ VERTICAL EDGE OF CUT SHALL BE TACKED.
- 5. THE SAME DEPTH OF PAVEMENT MATERIAL WHICH EXISTS SHALL BE REINSTALLED, BUT IN NO CASE SHALL THE ASPHALT BE LESS THAN 3" THICK.
- 6. THE ASPHALT PAVEMENT MATERIAL SHALL BE INSTALLED AND COMPACTED THOROUGHLY
- WITH A SMOOTH DRUM ROLLER TO ACHIEVE A SMOOTH LEVEL PATCH.
 7. REFER TO CITY OF RALEIGH STANDARDS FOR TRENCHES AND PIPE BEDDING, W-3. FOR
- ADDITIONAL DETAILS.
 8. NO HAND PATCHING ALLOWED.
- 9. PAVEMENT CUTS WITHIN NCDOT ROW SHALL CONFORM TO THE APPROVED ON SITE ENCROACHMENT PERMIT.


	CITY OF RALEIGH			
	DEPARTMENT OF PUBLIC UTILITIES			
	STANDARD ASPHALT PAVEMENT PATCH DETAIL			
DWG. NO.	REVISIONS	DATE	REVISIONS	DATE
W-2	RRH	3-31-00	A.B.B.	4-16-04
VV-Z	D.W.C.	11-1-99	J.P.S.	10-29-10

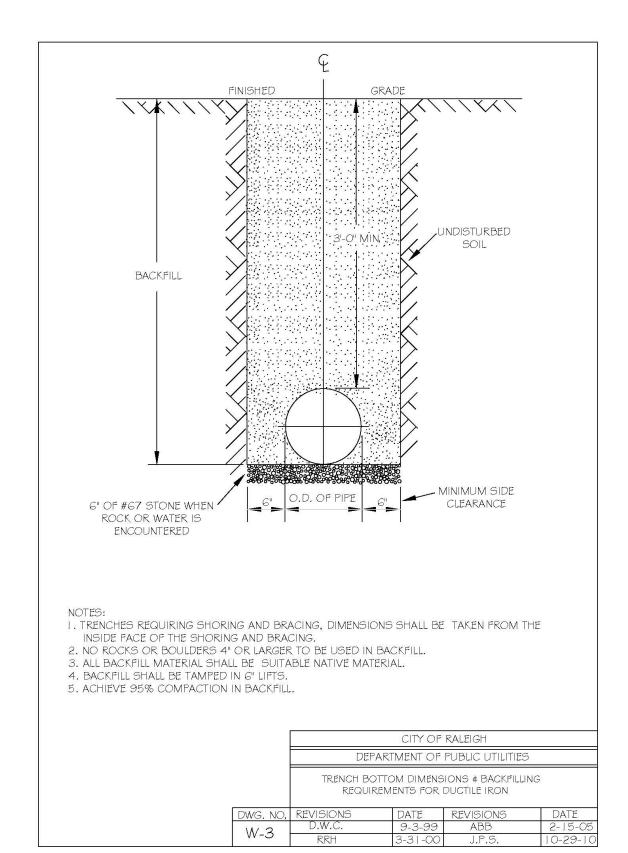


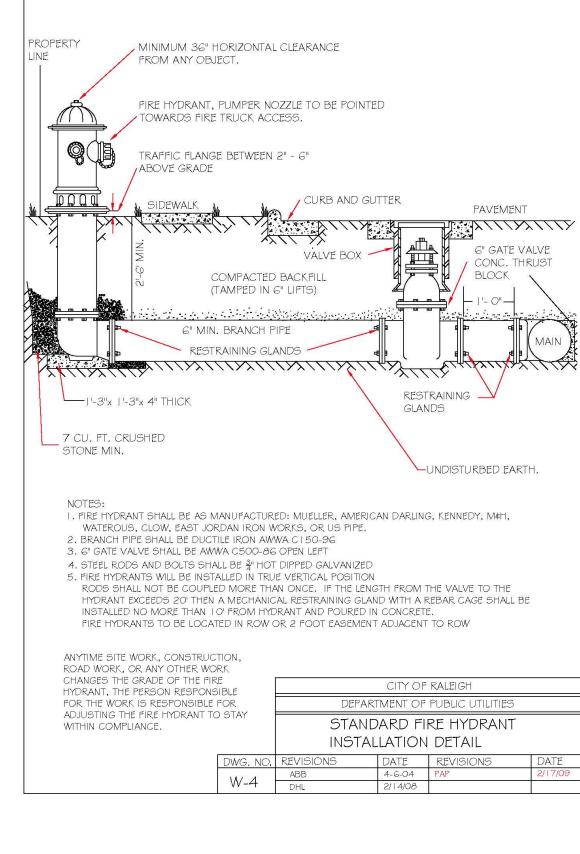


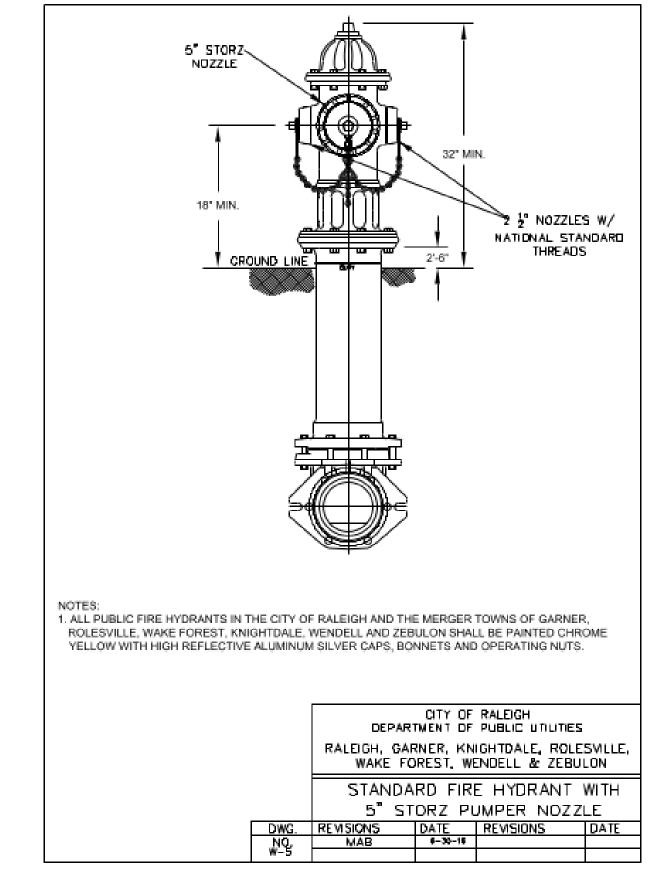


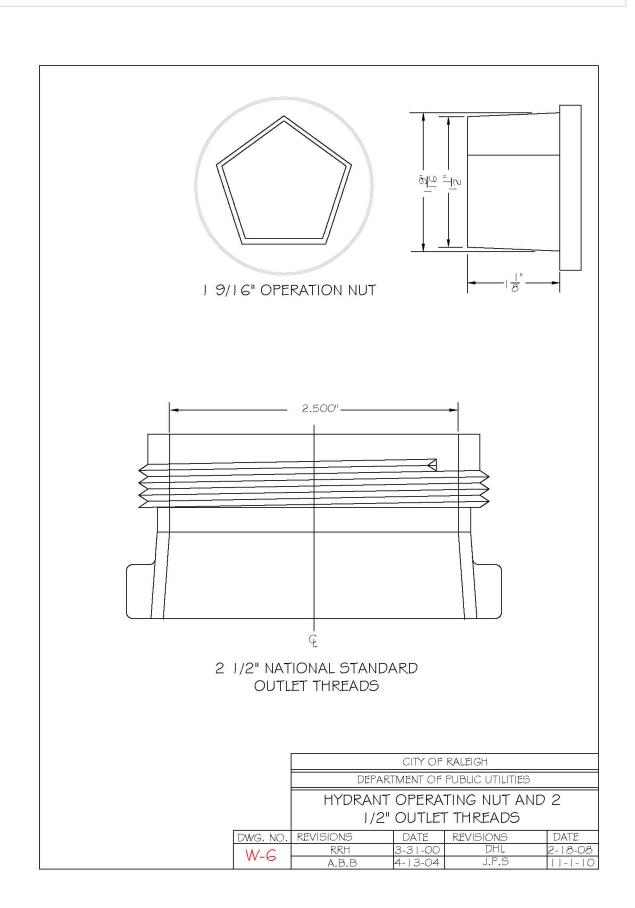

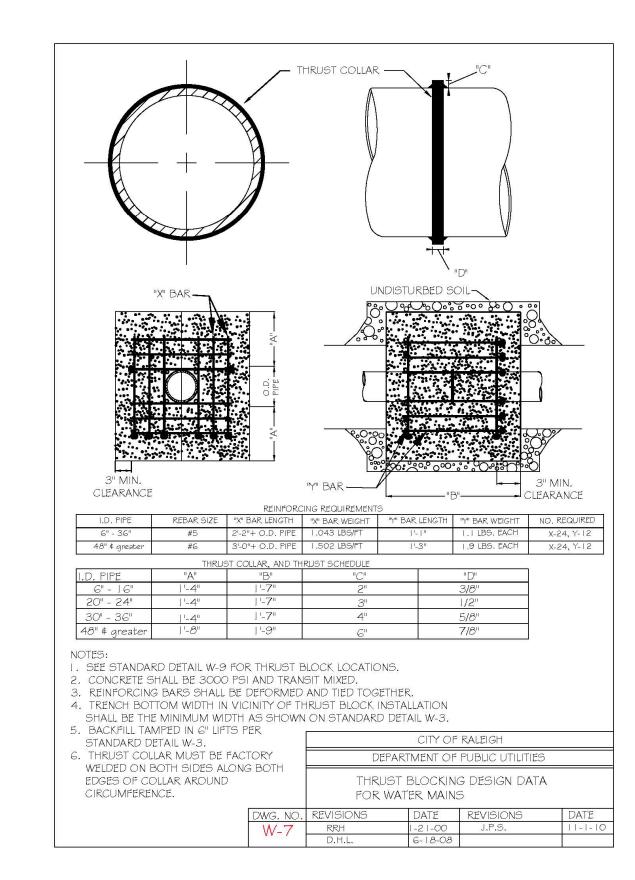

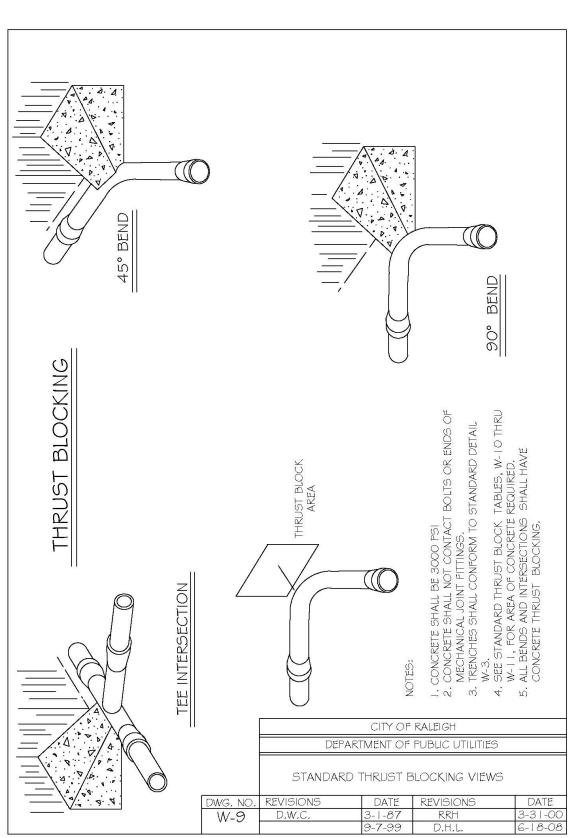

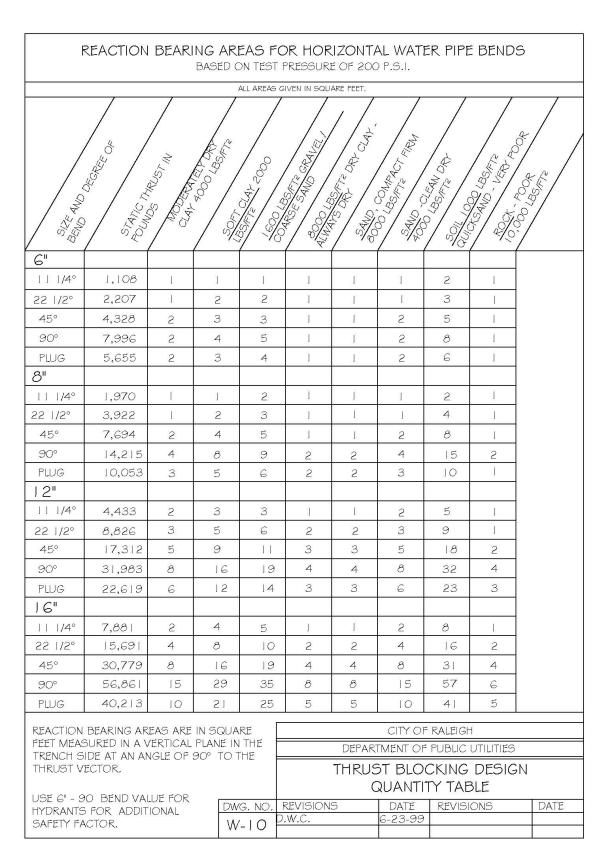

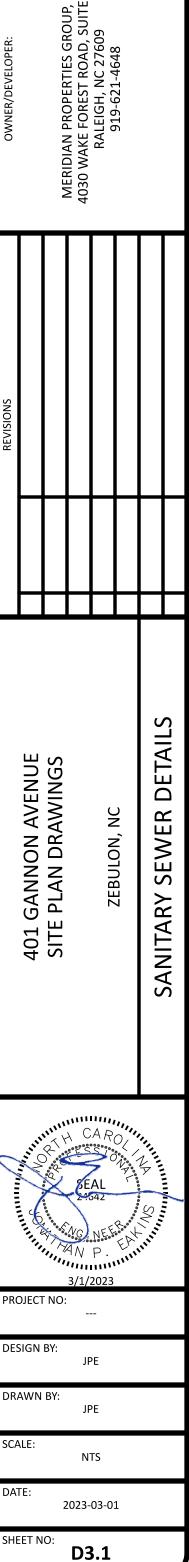

Company vil Engineers

Nau Iting Civ

The Consul