
# CONSTRUCTION DRAWINGS DOMINO'S ZEBULON




1000 HENDRICKS DR. ZEBULON, WAKE COUNTY, NORTH CAROLINA 27597

**CD SUBMITTAL #1 - JUNE 1, 2023** 

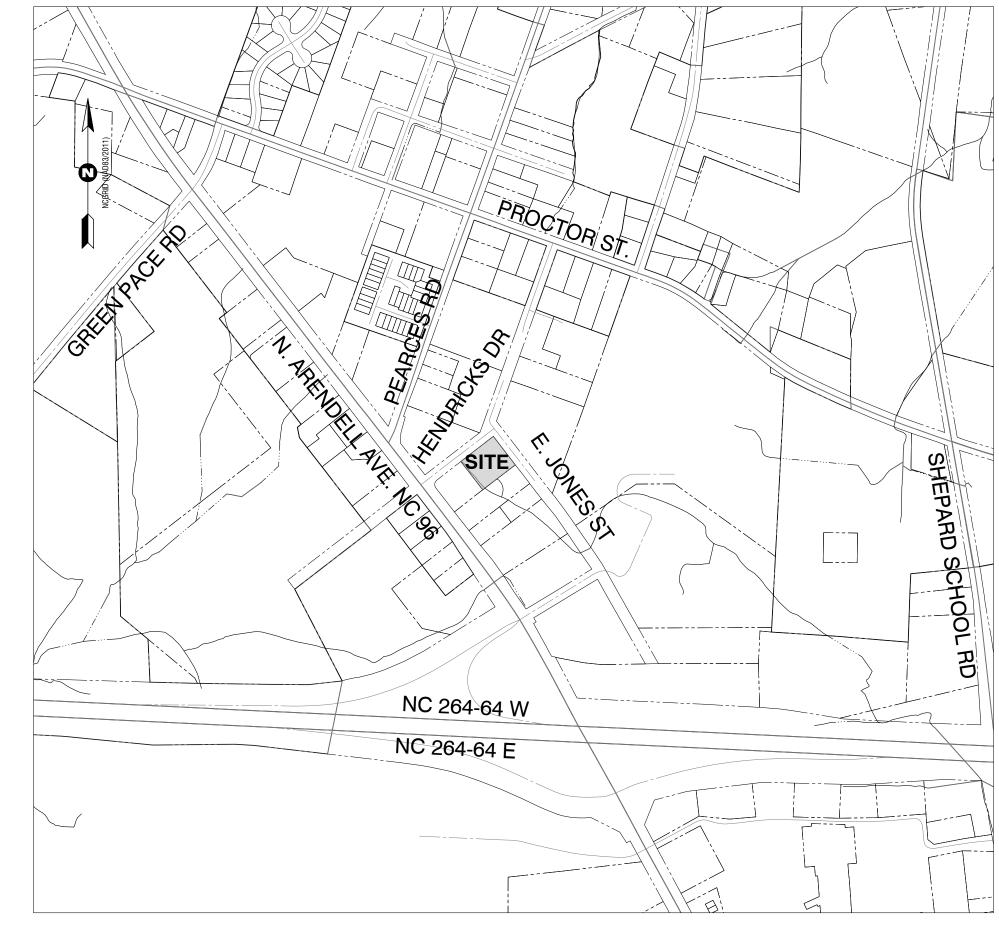

Sheet List Table					
Sheet Number	Sheet Title				
C1.01	COVER				
C1.02	RECORDED PLAT SURVEY				
C1.03	EXISTING CONDITION DEMOLITION PLAN				
C2.01	SITE PLAN				
C2.10	SITE DETAILS				
C2.11	SITE DETAILS				
C3.01	UTILITIES PLAN				
C3.10	UTILITIES DETAILS				
C3.11	UTILITIES DETAILS				
C4.01	STORMWATER AND GRADING PLAN				
C4.10	STORM DETAILS				
C4.11	STORM DETAILS				
L1.01	LANDSCAPE PLAN				
L1.02	LANDSCAPE NOTES, PLANT SCHEDULE, & DETAILS				
LP1	LIGHTING PLAN				

CD SUBMITTAL #2 - DECEMBER 7, 2023 A

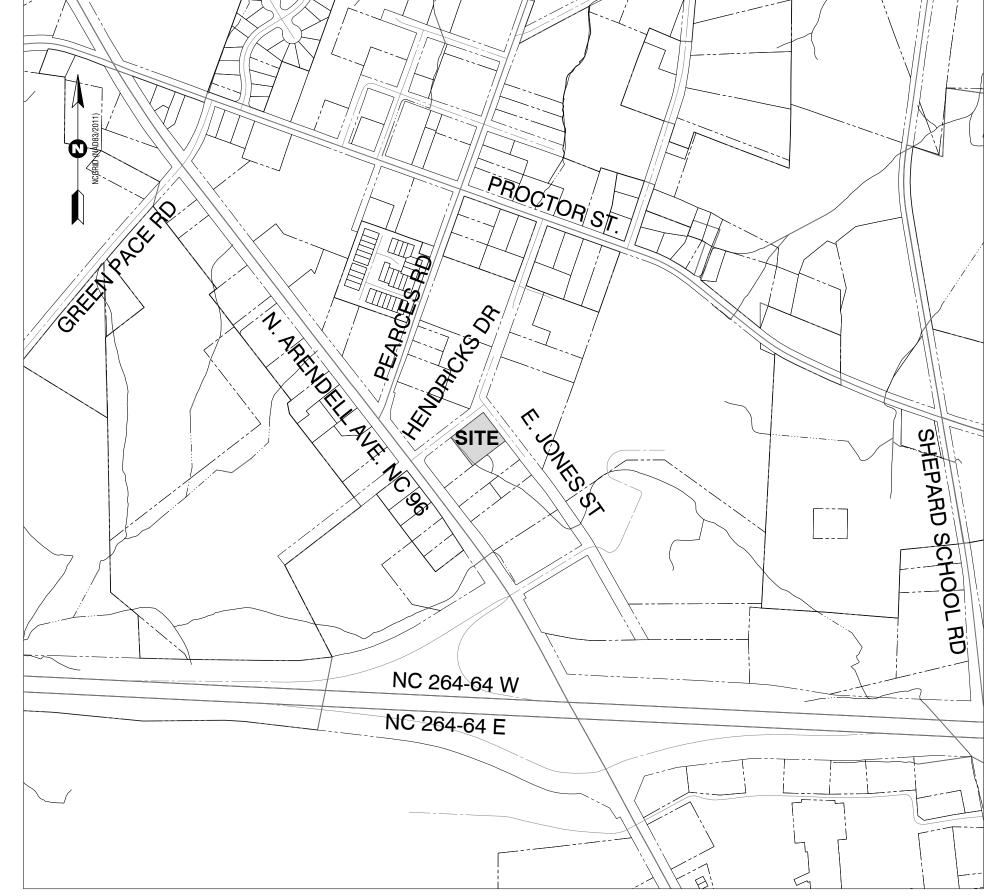

**VICINITY MAP** 1" = 500'

22. PLEASE BE ADVISED OF THE RULES WHICH PROTECT AND MAINTAIN EXISTING BUFFERS ALONG WATERCOURSES IN THE NEUSE RIVER BASINS. THIS RULE IS ENFORCED BY THE DIVISION OF WATER QUALITY (DWQ). DIRECT ANY QUESTIONS ABOUT THE APPLICABILITY OF THIS RULE TO YOUR PROJECT TO ROGER THORPE, REGIONAL WATER QUALITY SUPERVISOR, WASHINGTON REGIONAL OFFICE, AT (919) 946-6481.


Rivers & Associates, Inc. Greenville, NC



CIVIL ENGINEER

107 East Second Street Greenville, NC 27858 (252) 752-4135

Contact: Steve Janowski, PE sjanowski@riversandassociates.com

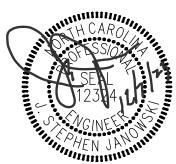

## **DEVELOPER/ARCHITECT**





EROSION CONTROL PLAN APPROVAL REQUIRED NOT REQUIRED LESS 1 ACRE

9. NCDOT AND TOWN OF ZEBULON DRIVEWAY PERMITS ARE NOT REQUIRED.

11. REFUSE COLLECTION SHALL BE PROVIDED BY PRIVATE CONTRACTOR

12. ALL DIMENSIONS ARE TO BACK OF CURB UNLESS OTHERWISE NOTED

15. ACCESS TO PUBLIC UTILITIES MUST BE MADE AVAILABLE AT ALL TIMES.

APPROVAL OF RALEIGH UTILITIES OR CITY OF RALEIGH, AS APPROPRIATE.

18. THIS SITE DOES NOT REQUIRE ANNEXATION UPON APPROVAL OF SITE PLAN.

20. ALL SITE LIGHTING SHALL COMPLY WITH THE TOWN OF ZEBULON LIGHTING STANDARD.

AND MUST BE APPROVED BY THE TRAFFIC ENGINEER.

STORMWATER MANAGEMENT PLAN APPROVAL REQUIRED NOT REQUIRED LESS 1 ACRES

10. ANY UNUSED DRIVEWAY SHALL BE CLOSED IN ACCORDANCE WITH TOWN OF ZEBULON DRIVEWAY ORDINANCE

13. APPROVAL OF SITE PLAN DOES NOT CONSTITUTE APPROVAL OF SIGNS. SEPARATE SIGN PERMITS ARE REQUIRED

16. ZEBULON ELECTRIC EASEMENT IS 10' IN WIDTH AND CENTERED OVER ELECTRIC LINES AS INSTALLED.

EXISTING STORM DRAINS LOCATED WITHIN PUBLIC STORM DRAINAGE EASEMENTS OR R/W

 $14.\;\;$  CONTRACTOR SHALL NOTIFY PUBLIC WORKS STREET MAINTENANCE DIVISION 48 HOURS PRIOR TO MAKING CONNECTIONS TO

17. NO BUILDINGS, STRUCTURES OR OTHER IMPROVEMENTS, MATERIALS AND SURFACES, INCLUDING BUT NOT LIMITED TO PRINCIPLE AND ACCESSORY STRUCTURES AND ADDITIONS AND APPURTENANCES THERETO, SIGNAGE, FENCES, WALLS, MECHANICAL EQUIPMENT, CANOPIES, ANTENNAS, MASTS, DEBRIS, SOLID WASTE COLLECTION CONTAINERS, MAIL RECEPTACLES AND IMPERVIOUS SURFACES SHALL ENCROACH WITHIN ANY DEDICATED EASEMENT WITHOUT PRIOR

19. LANE CLOSURES ON THOROUGHFARE ROADS ARE ONLY PERMITTED BETWEEN THE HOURS OF 9:00AM AND 4:00PM,


21. NEW BUILDINGS MUST COMPLY WITH NC FIRE CODE SECTION 510-EMERGENCY RESPONDER RADIO COVERAGE.

MONDAY THROUGH FRIDAY, UNLESS OTHERWISE PERMITTED BY THE TRAFFIC ENGINEER IN ADDITION , THERE WILL BE NO LANE CLOSURES ON HOLIDAYS INCLUDING THE DAY BEFORE OR AFTER SAID HOLIDAY. A TRAFFIC CONTROL PLAN PREPARED IN ACCORDANCE WITH THE NCDOT MANUAL OF UNIFORM TRAFFIC CONTROL DEVISES IS REQUIRED FOR ALL LANE CLOSURES


BUILDINGS MUST MEET ALL APPLICABLE BUILDING CODES. SITE SHALL MEET ALL RELATIVE NORTH CAROLINA ACCESSIBILITY CODE


353 EAST SIX FORKS ROAD SUITE 230 RALEIGH, NC 27609 (919) 594-1626

Engineers **Planners** Surveyors Landscape Architects

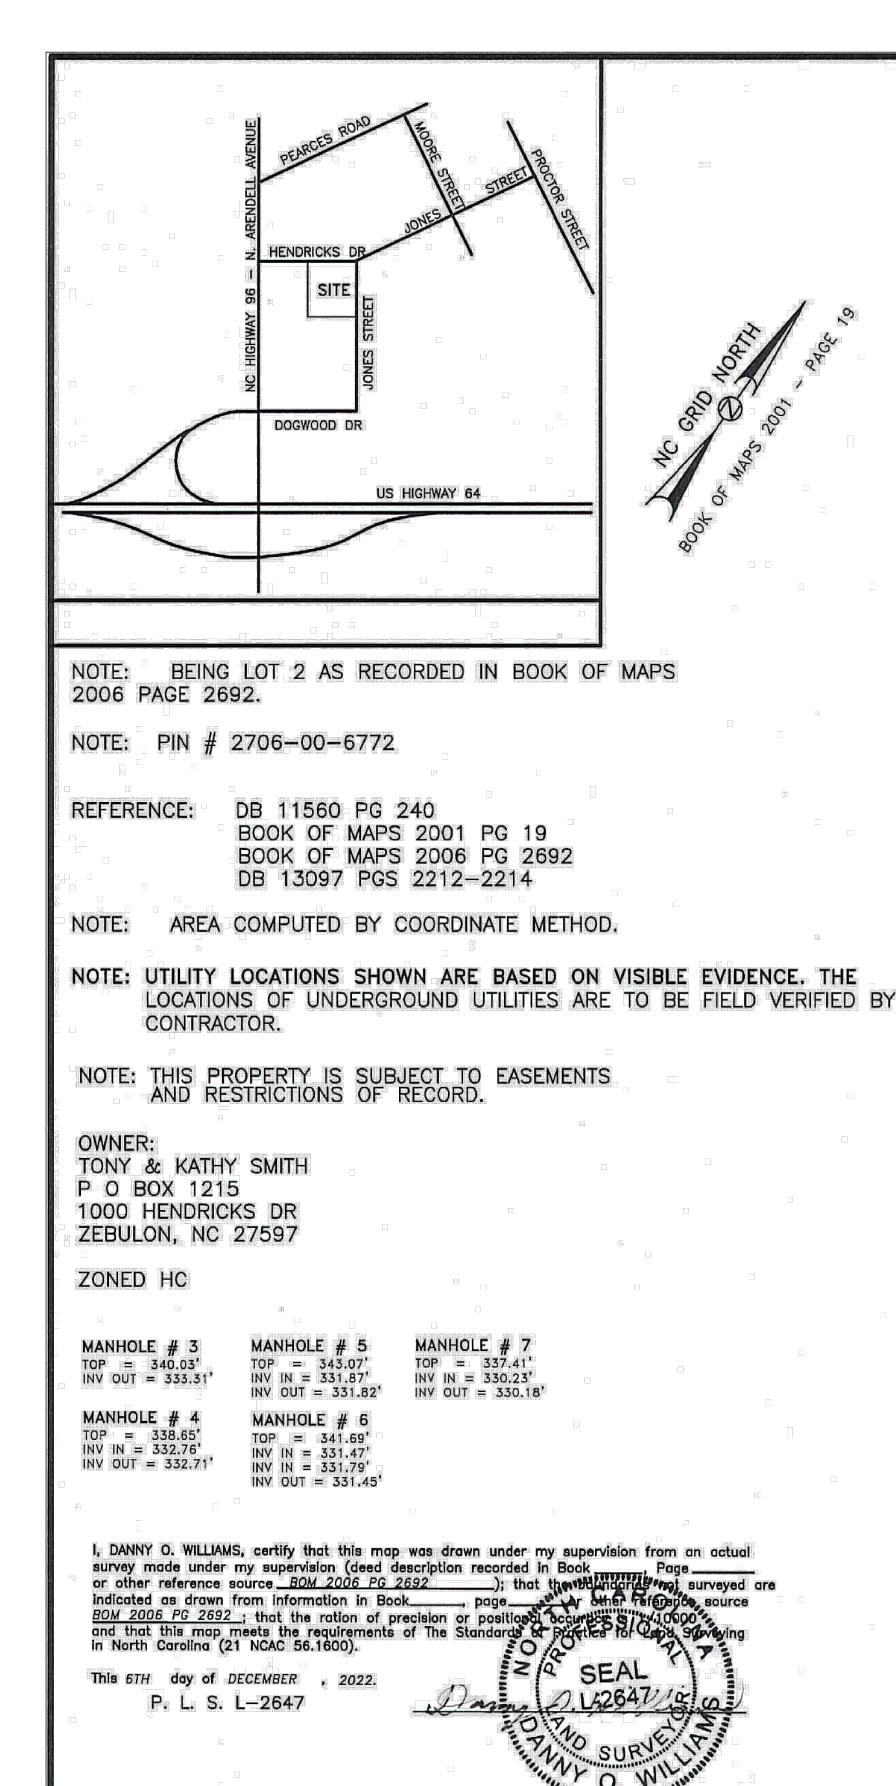

FLOOD CERTIFICATION

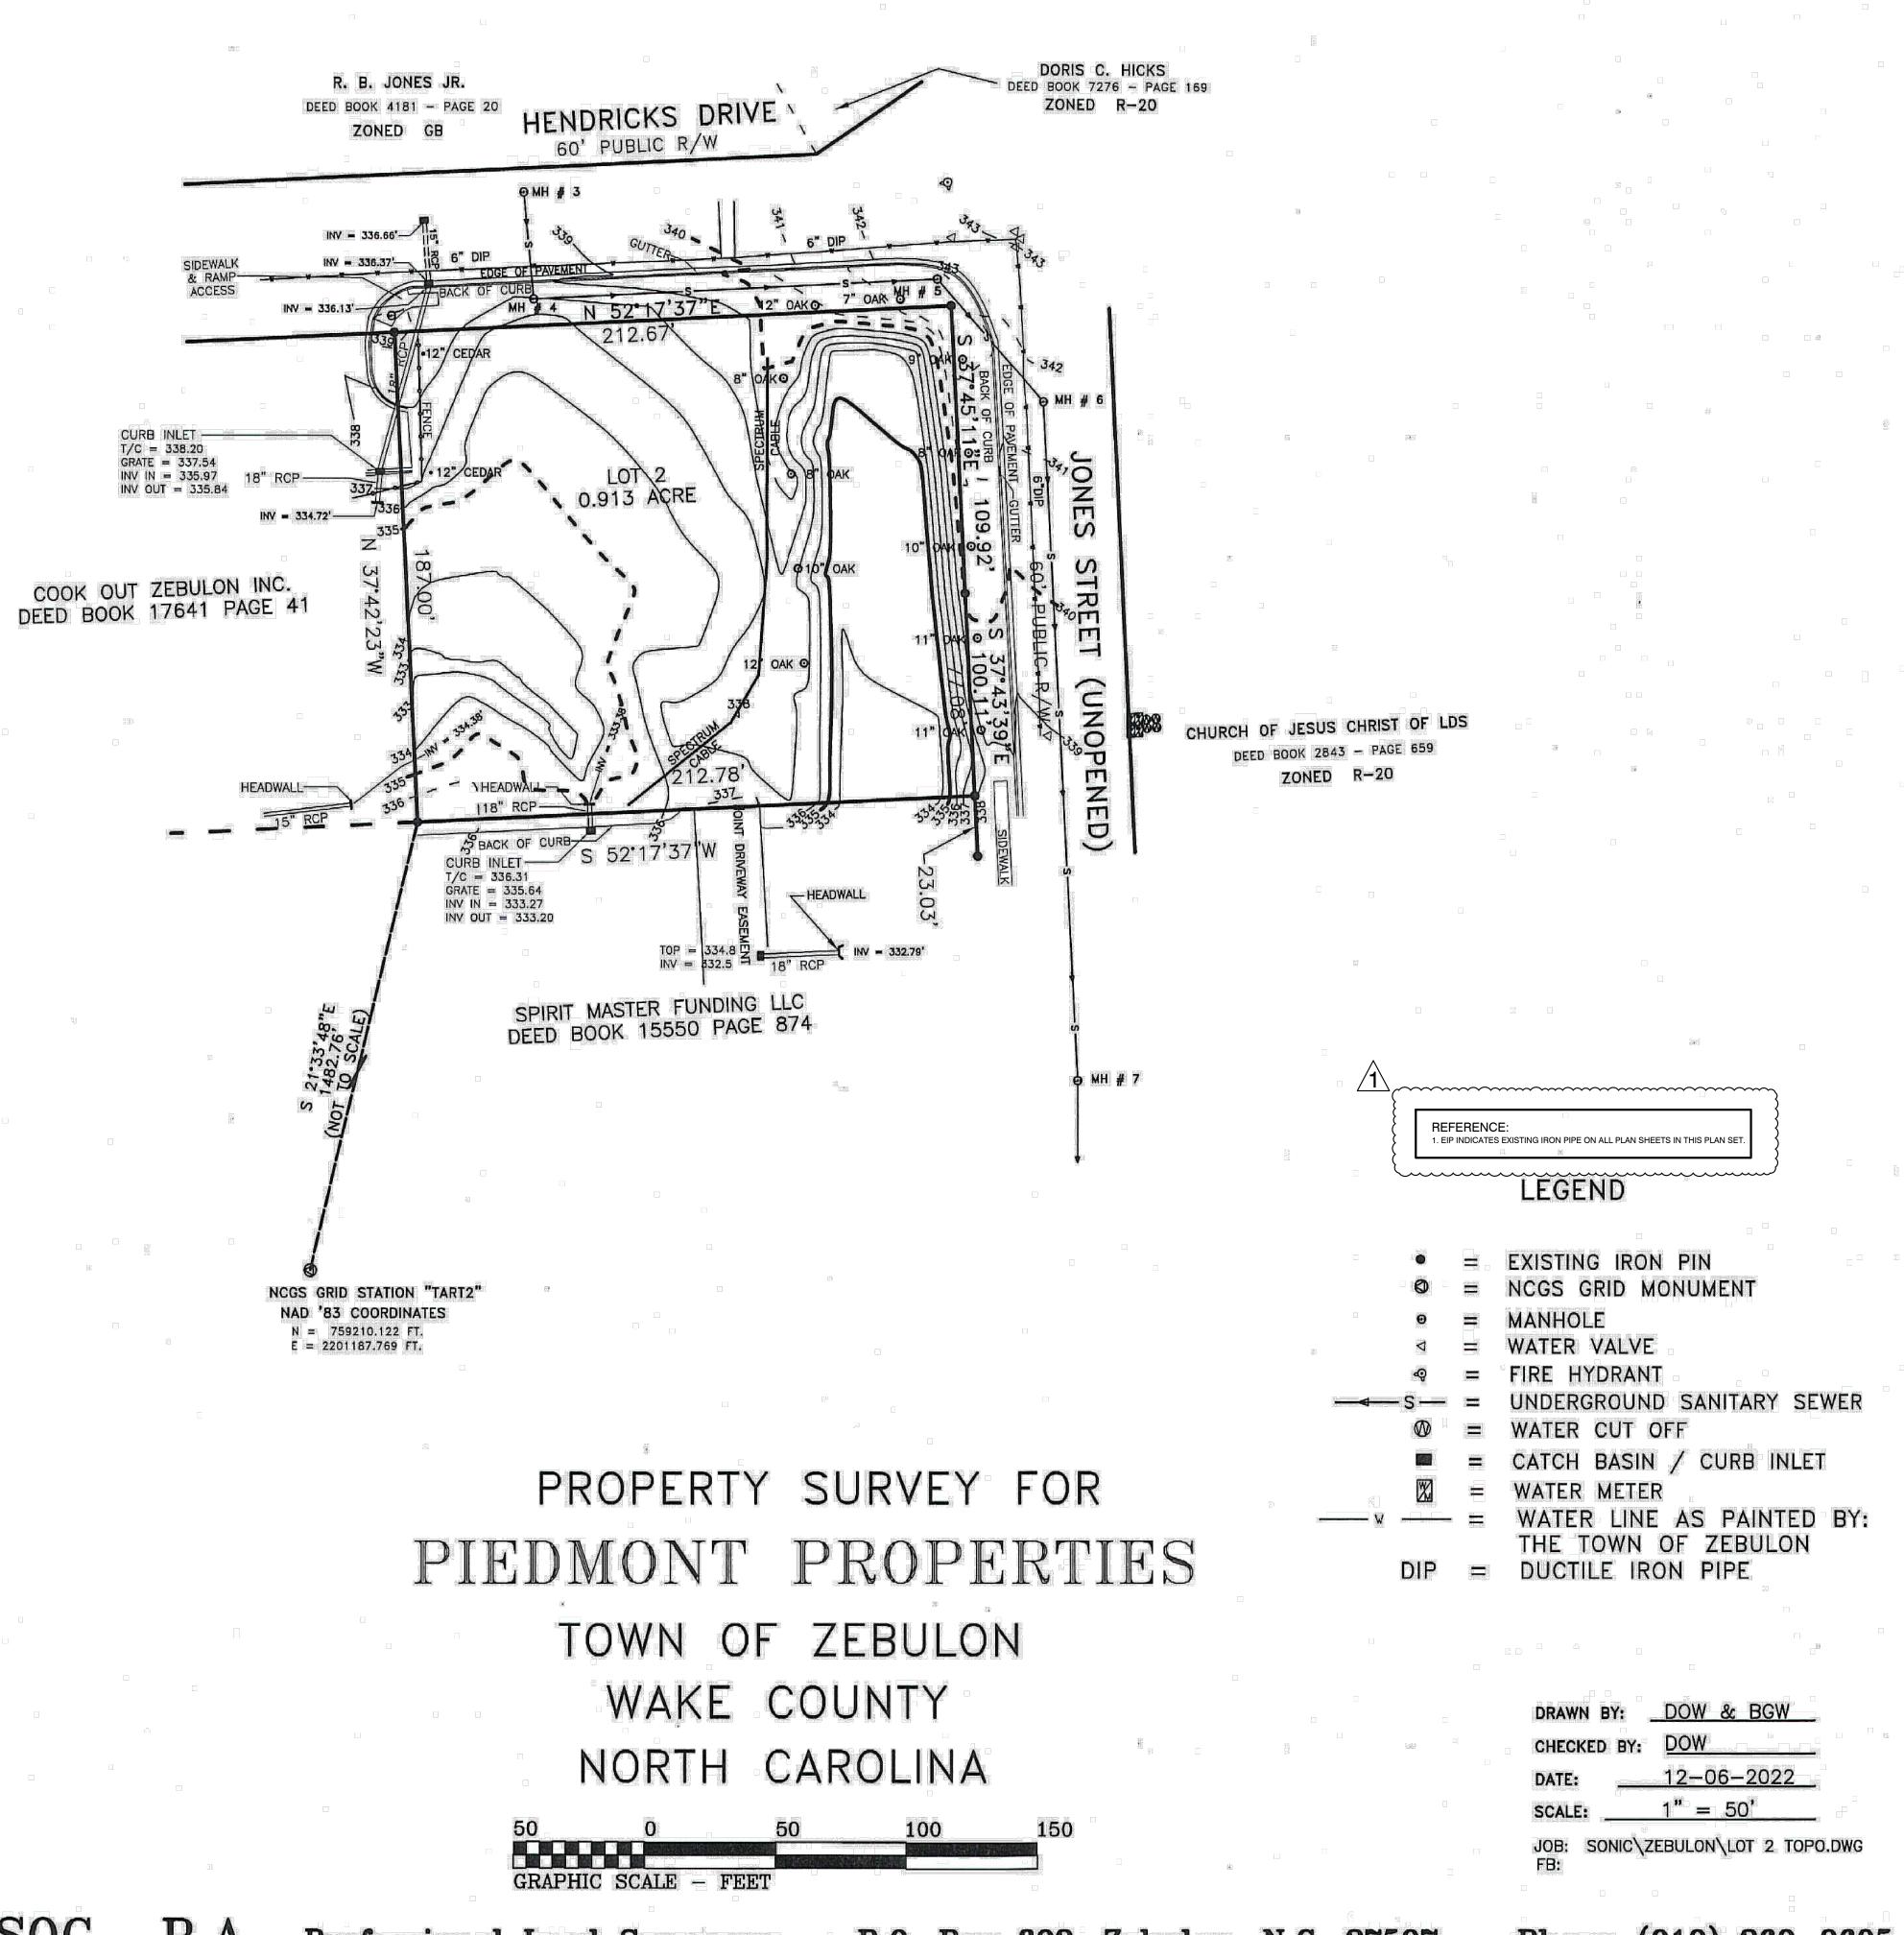

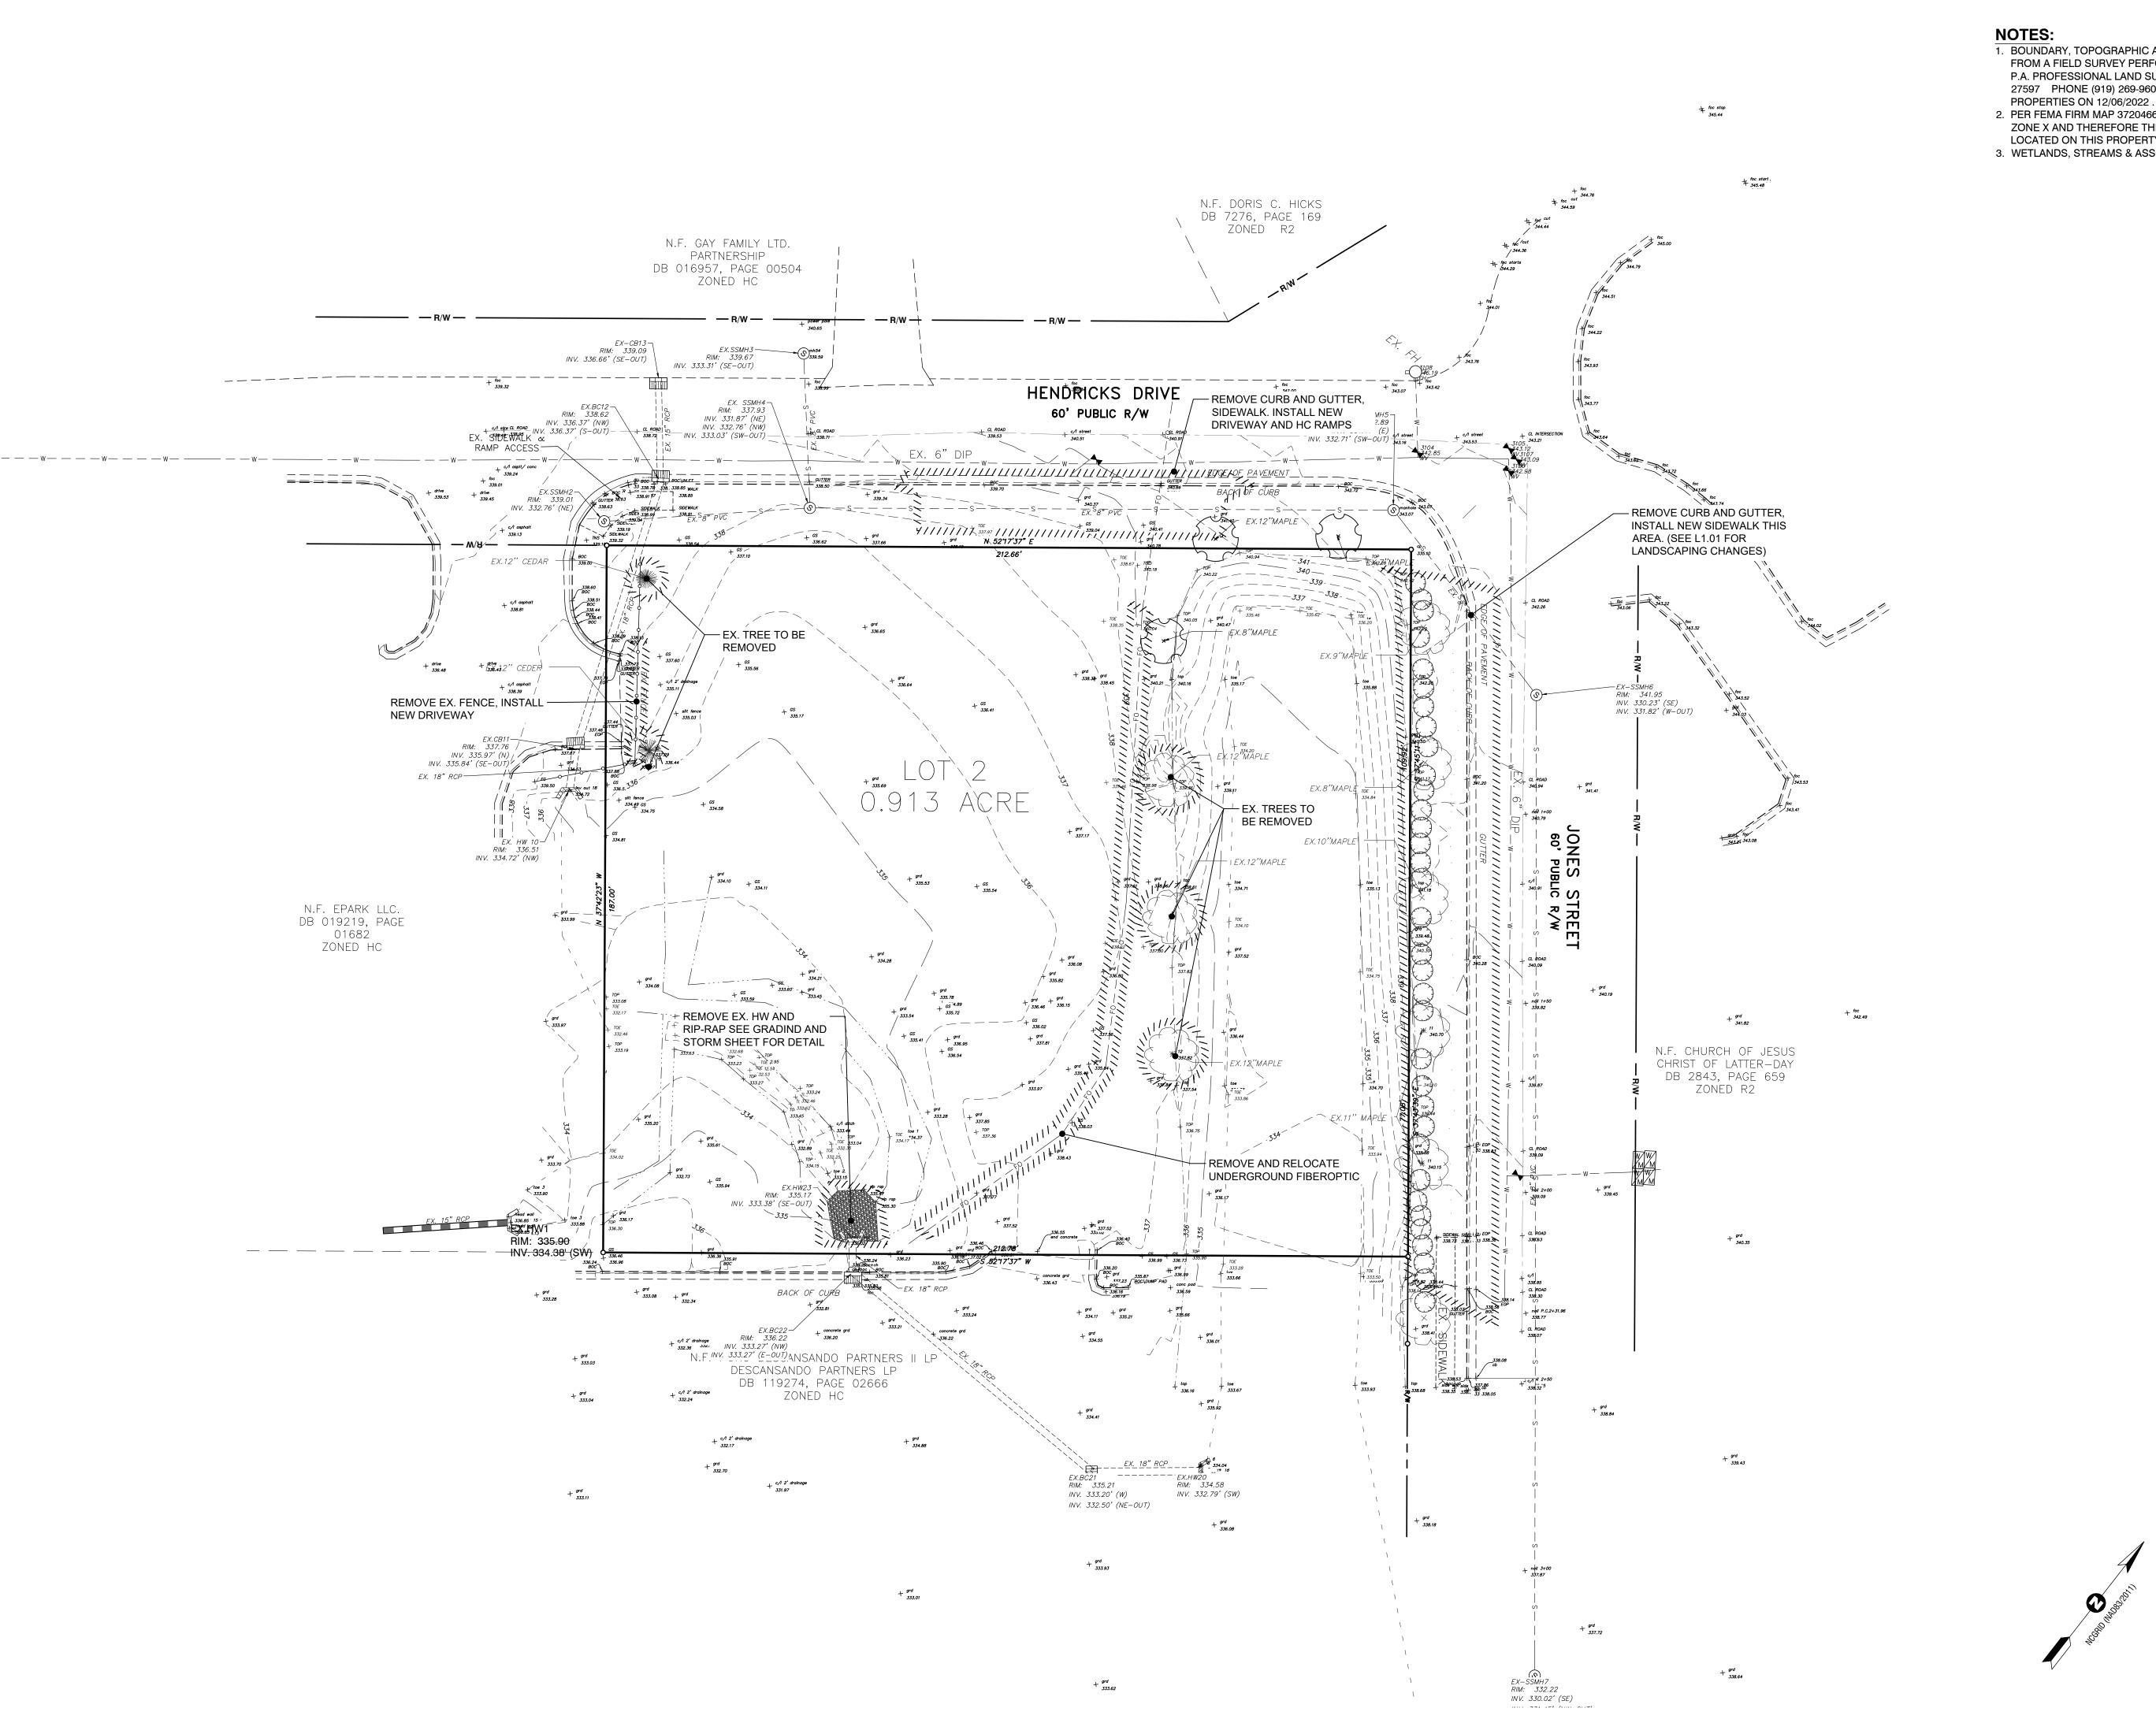

- 1. BOUNDARY, TOPOGRAPHIC AND PLANIMETRIC FEATURES SHOWN ARE FROM A FIELD SURVEY PERFORMED BY WILLIAMS PEARCE & ASSOC., P.A. PROFESSIONAL LAND SURVEYORS P.O. BOX 892, ZEBULON, N.C. 27597 PHONE (919) 269-9605 PROPERTY SURVEY FOR: PIEDMONT
- 2. PER FEMA FIRM MAP 3720466000L DATED 7/7/14, THIS PROJECT IS IN ZONE X AND THEREFORE THERE IS NO REGULATORY FLOODPLAIN LOCATED ON THIS PROPERTY.
- 3. WETLANDS, STREAMS & ASSOCIATED BUFFERS TO BE DETERMINED.

riversanda Six Forks Place 353 E. Six Forks Raleigh, NC 276 919.594.1626

SEAL MAINTENNERS OF THE N JANUARITH

**REVISIONS:** 

$\overline{\Psi}$	CONSTRUCTION DRAWINGS SUBMITTAL #2	12/07/23	
	CLIENT REVIEW	11/21/23	
	TRC REVIEW PLAN	11/07/23	
	CONSTRUCTION DRAWINGS SUBMITTAL #1	06/01/23	
ON	DESCRIPTION	DATE B	m
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O'S ZEBULON

WAKE COUNTY ON NORTH CAROLINA
ONDITION DEMOLITION


DOMINOF ZEBULON WAKE COUNTY

DATE:

	®			
			DESIGNED BY:	JSJ/N
	CALL BEFORE YOU DIG!		DRAWN BY:	Ŋ
	WWW.NC811.ORG N.C. ONE-CALL CENTER		CHECKED BY:	J
	IT'S THE LAW!		PROJECT No.	20230
			DRAWING No.	W-40
•	0 10'	20'	SCALE:	AS SHOV
	,,,,,,,,,,,,,,,,,,,,,,,,,,,,,,,,,,,,,,,		CHEET NO	• • • • •

SCALE 1 inch = 20 ft

SHEET No.

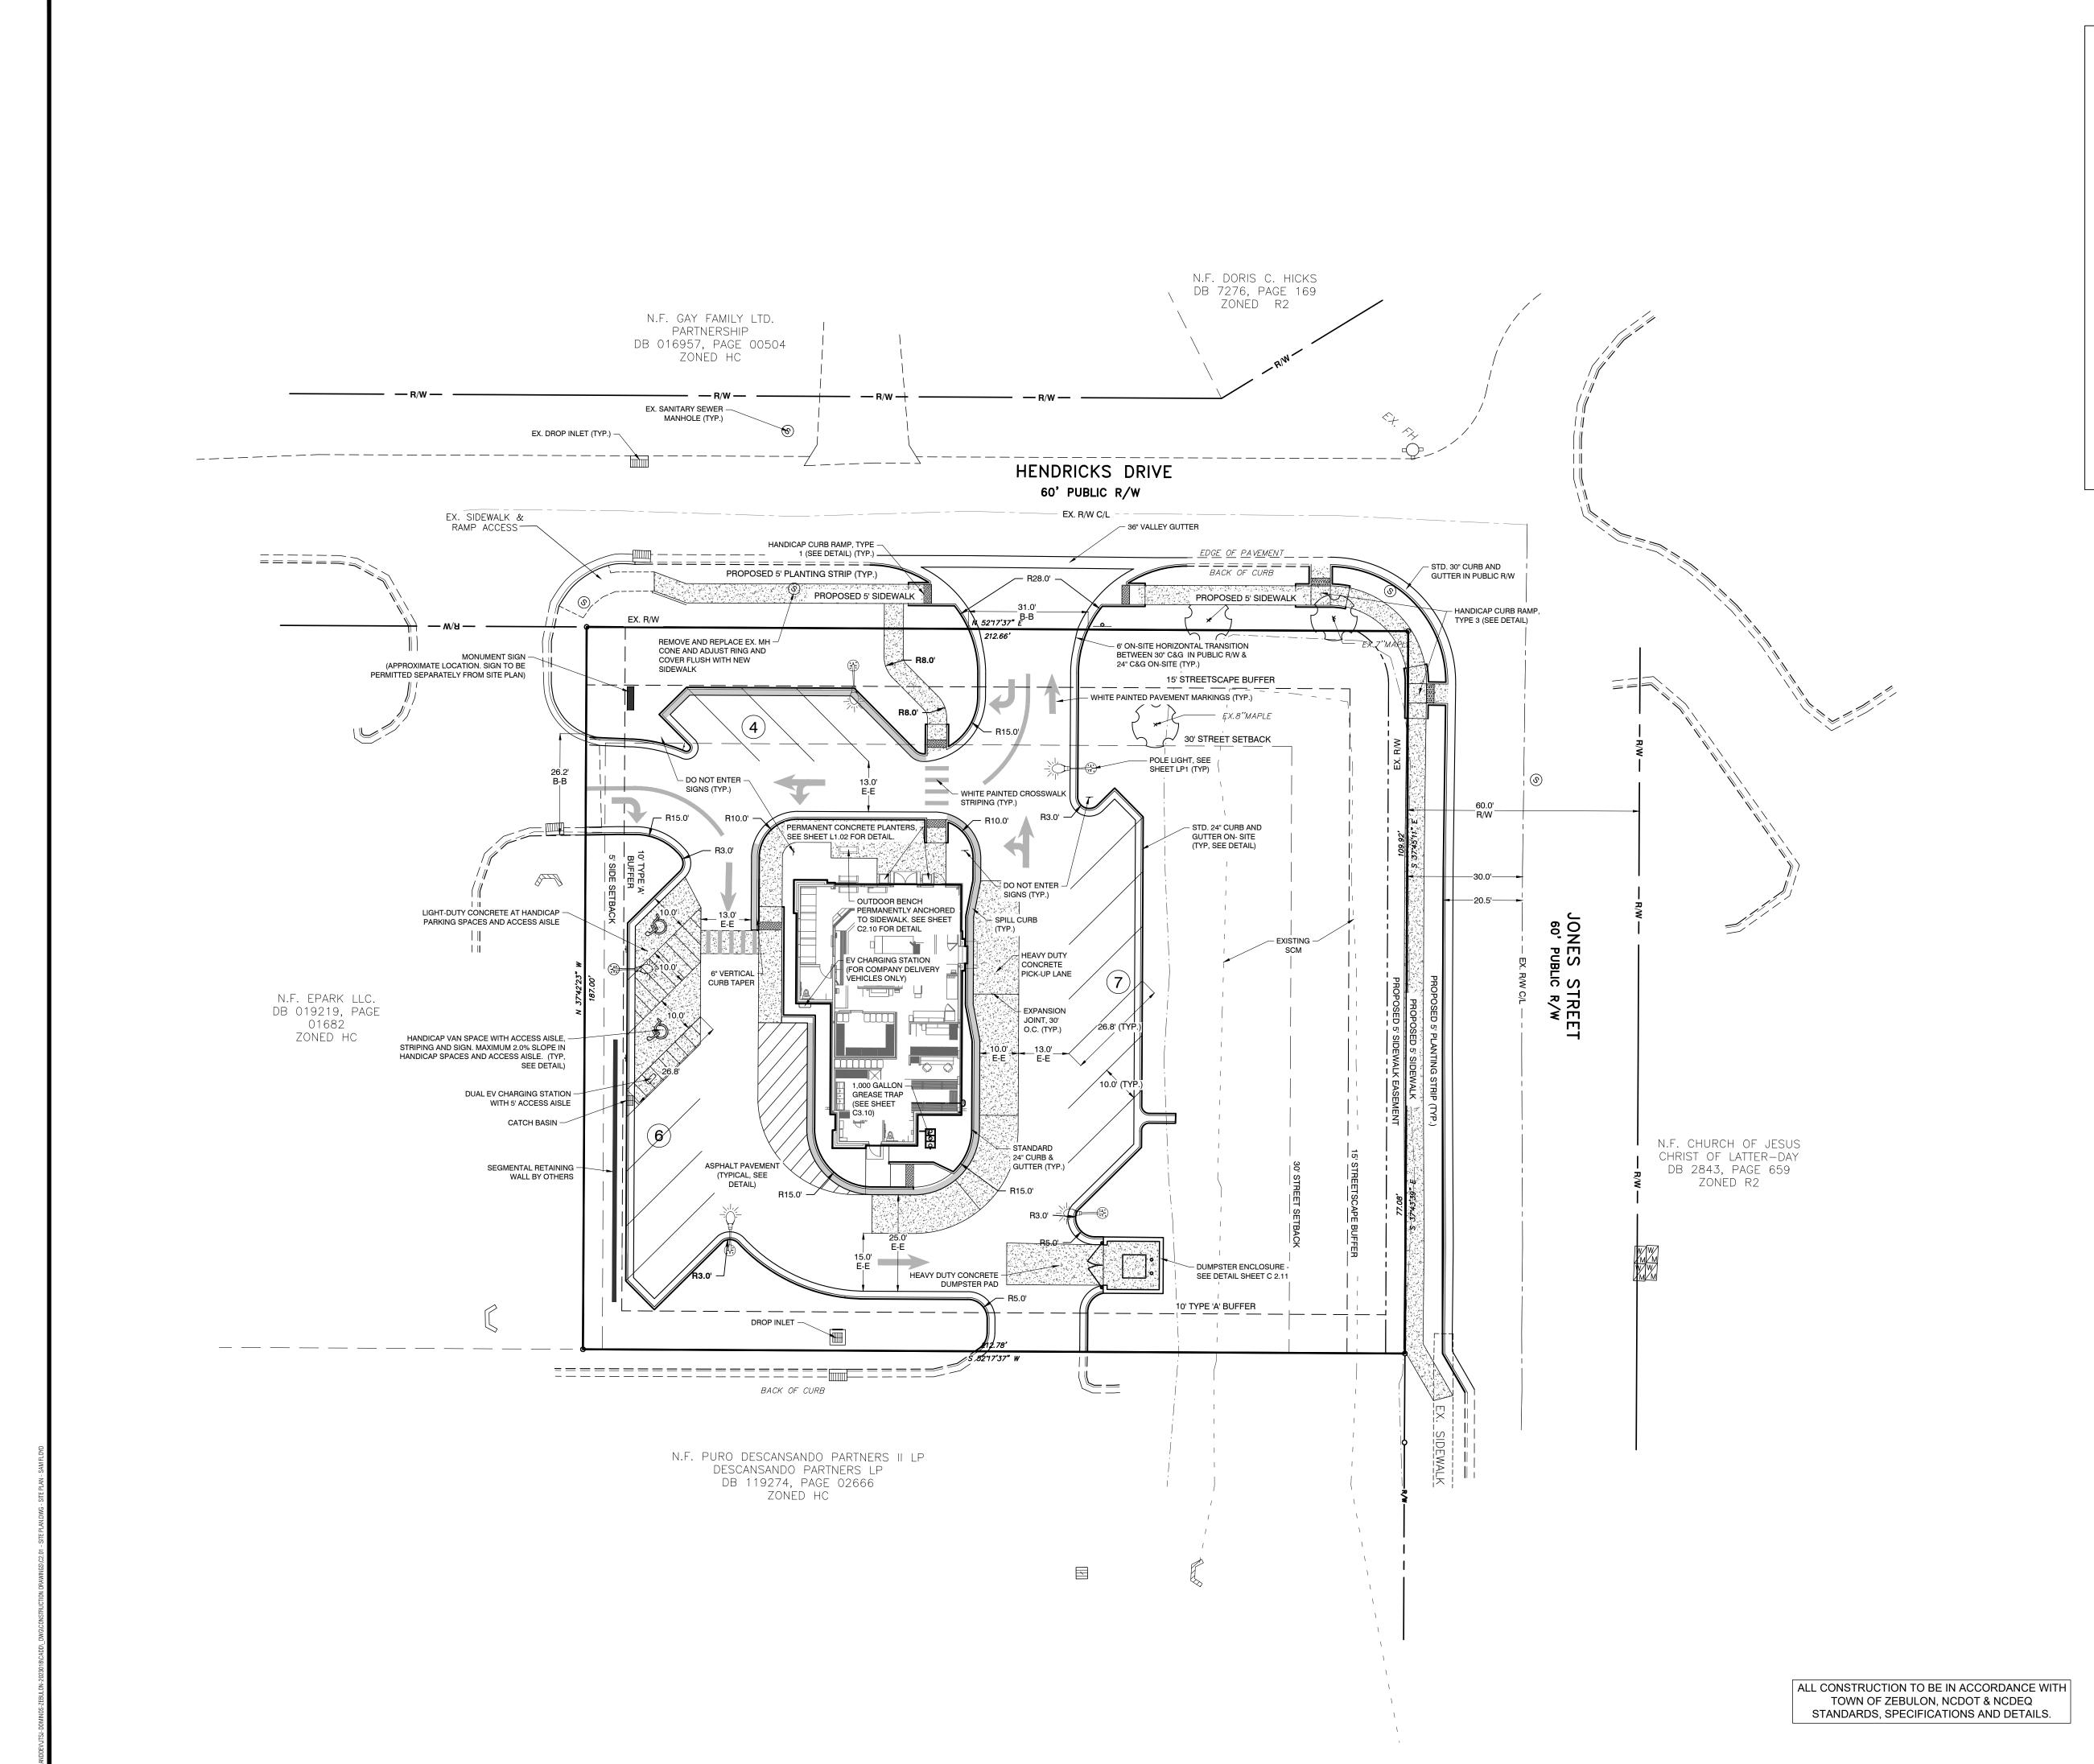

SITE DATA TABLE

TOWNSHIP -

PARKING -

PROPERTY INFORMATION / SITE ADDRESSES NC PIN - 27-0600-6772

ADDRESS - 1000 HENDRICKS DR

ZEBULON, WAKE COUNTY, NORTH CAROLINA 27597

LITTLE RIVER (PER IMAPS) OWNER/ DEVELOPER -JTSJ INC.

9107 S TRYON ST STE. F, CHARLOTTE, NC 28273 SITE AREA -0.91 AC (PER RIVERS SURVEY) EXISTING - VACANT / STORMWATER CONTROL MEASURE LAND USE -PROPOSED - RESTAURANT WITH DRIVE-THROUGH PICK-UP LANE

HC- HEAVY COMMERCIAL ZONING -SETBACKS -

REAR -

STREET - 30' SIDE - 0'; 5' IF PROVIDED

BUFFERS -15' STREETSCAPE BUFFER ALONG HENDRICKS DR & JONES ST 10' TYPE 'A' PERIMETER BUFFER ALONG ADJACENT PROPERTIES BUILDING DATA -

PROPOSED BUILDING FOOTPRINT = 2,507 SF REQUIRED - 1 SPACE / 4 SEATS 3 BOOTHS @ 4 SEATS/BOOTH = 12 SEATS

3 BENCHES @ 4 SEATS/BENCH = 12 SEATS 12 + 12 = 24 SEATS TOTAL, 24 / 4 = 66 PARKING SPACES REQUIRED

PROVIDED - 17 PARKING SPACES, INCL. 2 VAN ACCESSIBLE HANDICAP SPACES.

MINIMUM DIMENSIONS: 10' X 20'

IMPERVIOUS SURFACE - EXISTING - N/A

PROPOSED - ASPHALT PAVEMENT -+/-14,172 SF (INCLUDES C+G) CONCRETE -+/- 3,093 SF

BUILDING -

TOTAL -+/- 19,772 SF (+/- 0.454 AC) PROPOSED IMPERVIOUS PERCENTAGE -+/- 49.25%

+/- 2,507 SF

**REVISIONS:** 

### GENERAL NOTES:

- 1. ALL SITE WORK SHALL BE DONE IN ACCORDANCE WITH THE PLANS PREPARED BY RIVERS AND ASSOCIATES, INC., THE CURRENT REQUIREMENTS OF THE TOWN OF ZEBULON, THE APPLICABLE SECTIONS OF THE NCDOT STANDARD SPECIFICATIONS FOR ROADWAY CONSTRUCTION, AND ALL OTHER PERTINENT FEDERAL, STATE AND LOCAL LAWS. 2. THE CONTRACTOR SHALL COMPLY AT ALL TIMES WITH APPLICABLE FEDERAL, STATE AND LOCAL LAWS, PROVISIONS, AND POLICIES GOVERNING SAFETY AND HEALTH, INCLUDING
- THE FEDERAL CONSTRUCTION SAFETY ACT (PUBLIC LAW 91-54), FEDERAL REGISTER, CHAPTER XVII, PART 1926 OF TITLE 29 REGULATIONS, OCCUPATIONAL SAFETY AND HEALTH REGULATIONS FOR CONSTRUCTION, AND SUBSEQUENT PUBLICATIONS UPDATING THESE REGULATIONS. 3. THE CONTRACTOR SHALL BE RESPONSIBLE FOR EXAMINING THE AREAS AND CONDITIONS UNDER WHICH THE PROJECT IS TO BE CONSTRUCTED PRIOR TO THE SUBMISSION OF A
- REVIEWED THE SITE AND IS FAMILIAR WITH CONDITIONS AND CONSTRAINTS OF THE SITE. 4. BEFORE EXCAVATION, ALL UNDERGROUND UTILITIES SHALL BE LOCATED IN THE FIELD BY THE PROPER AUTHORITIES. THE CONTRACTOR SHALL NOTIFY N.C. ONE CALL AT 1-800-632-4949. THE LOCATION OF ALL UTILITIES AND UNDERGROUND STRUCTURES ARE APPROXIMATE AND MAY NOT ALL BE SHOWN. IT IS THE RESPONSIBILITY OF THE CONTRACTOR TO DETERMINE THE EXISTENCE AND EXACT LOCATION OF ALL UTILITIES AND UNDERGROUND STRUCTURES.

BID. SUBMISSION OF A BID SHALL BE CONSTRUED TO MEAN THE CONTRACTOR HAS

- 5. CONTRACTOR SHALL REFER TO THE GEOTECHNICAL REPORT PRIOR TO INITIATION OF ANY EARTHWORK ACTIVITY.
- 6. CONTRACTOR SHALL NOTIFY PUBLIC WORKS STREET MAINTENANCE DIVISION 48 HOURS PRIOR TO MAKING CONNECTIONS TO EXISTING STORM DRAINS LOCATED WITHIN PUBLIC
- STORM DRAINAGE EASEMENTS OR R/W. 7. REFER TO C1.02 FOR SURVEY CONTROL INFORMATION.
- 9. PER FEMA FIRM MAP 3720466000L DATED 7/7/14, THIS PROJECT IS IN ZONE X AND THEREFORE THERE IS NO REGULATORY FLOODPLAIN LOCATED ON THIS PROPERTY. 10. BUILDINGS, STRUCTURES OR OTHER IMPROVEMENTS, MATERIALS AND SURFACES. INCLUDING BUT NOT LIMITED TO PRINCIPLE AND ACCESSORY STRUCTURES AND ADDITIONS AND APPURTENANCES THERETO, SIGNAGE, FENCES, WALLS, MECHANICAL
- & THE CITY OF RALEIGH PUBLIC UTILITIES DEPARTMENT. 11. SOIL EROSION AND SEDIMENTATION CONTROL PLAN IS NOT APPLICABLE, THE SITE
- DISTURBANCE IS LESS THAN ONE ACRE. 12 WETLANDS ARE VALUABLE NATURAL RESOURCES THAT PROVIDE IMPORTANT THE FEDERAL GOVERNMENT UNDER SECTION 404 OF THE CLEAN WATER ACT. JURISDICTIONAL WETLANDS MAY INCLUDE THE PINE-SHRUB POCOSINS THAT ARE
- THE U.S. ARMY CORPS OF ENGINEERS PRIOR TO COMMENCEMENT OF SUCH LAND-DISTURBING ACTIVITIES. PLEASE CONTACT MS. TRACY WHEELER, TELEPHONE (252) 975-1616 FOR A WETLAND DETERMINATION AND INFORMATION REGARDING SPECIFIC PERMIT REQUIREMENTS. WETLANDS DETERMINATION PENDING, BY OTHERS.
- 15. ALL AREAS NOT PAVED SHALL BE TOPSOILED, SEEDED, MULCHED OR LANDSCAPED/SODDED UNLESS OTHERWISE NOTED IN THE CONSTRUCTION DRAWINGS,
- 16. ALL REQUIRED IMPROVEMENTS SHALL COMPLY WITH THE TOWN OF ZEBULON ZONING
- 17. REFUSE COLLECTION SHALL BE PROVIDED BY PRIVATE CONTRACTOR.

1. EXISTING STORMWATER MANAGEMENT DETENTION BASIN A. ON-SITE ALLOWABLE IMPERVIOUS SURFACE AREA = B. SONIC IMPERVIOUS SURFACE AREA =

### WITHIN RIGHT OF WAY SHALL BE THERMOPLASTIC AND SHALL BE INSTALLED IN ACCORDANCE WITH NCDOT STANDARDS AND SPECIFICATIONS. 2. EXISTING ON-SITE FIBER OPTIC LINES TO BE REROUTED BY CONTRACTOR.

2. POWER POLES WHICH CONFLICT WITH FIELD LOCATED HC RAMPS ARE TO BE RELOCATED BY APPROPRIATE UTILITY COMPANY.





SCALE 1 inch = 20 ft

SF/MS

SF/MS

JSJ/PRM

2023018

W-408<sup>-</sup>

AS SHOWN

DESIGNED BY:

CHECKED BY:

PROJECT No.

DRAWING No.

DRAWN BY:

8. CONTRACTOR SHALL REFER TO OTHER PLANS WITHIN THIS CONSTRUCTION SET FOR OTHER PERTINENT INFORMATION. EQUIPMENT, CANOPIES, ANNTENNAS, MASTS, DEBRIS, SOLID WASTE COLLECTION CONTAINERS, MAIL RECEPTACLES, AND IMPERVIOUS SURFACES SHALL NOT ENCROACH WITHIN ANY DEDICATED EASEMENT WITHOUT PRIOR APPROVAL OF TOWN OF ZEBULON ECOLOGICAL FUNCTIONS. BE ADVISED THAT ACTIVITIES IN WETLANDS ARE REGULATED BY COMMON IN THIS REGION. IF ANY PRIVATE LAND OWNER, DEVELOPER, CORPORATION, OR OTHER PERSON PROPOSES TO UNDERTAKE CONSTRUCTION/FILLING ACTIVITIES IN OR NEAR A LAKE. STREAM. CREEK TRIBUTARY OR ANY UNNAMED BODY OF WATER INCLUDING ITS ADJACENT WETLANDS, FEDERAL PERMIT AUTHORIZATION MAY BE REQUIRED FROM

13. APPROVAL OF SITE PLAN DOES NOT CONSTITUTE APPROVAL OF SIGNS. SEPARATE SIGN

PERMITS ARE REQUIRED. 14. ALL SLOPES SHALL BE 3:1 (HORIZONTAL:VERTICAL) MAXIMUM UNLESS NOTED

SITE SPECIFICATIONS OR INSTRUCTED BY THE OWNER.


18. CONSTRUCTION OF ROADWAY EXTENSION BY OTHERS


## STORMWATER MANAGEMENT NOTES:


1.89 AC = 82,328 SF 0.84 AC = 36,590 SF C. CAPITAL BANK IMPERVIOUS SURFACE AREA = 0.56 AC = 24,394 SF2. ALLOWABLE IMPERVIOUS SURFACE AREA FOR SITE = 0.48 AC = 21,344 SF 3. PROPOSED IMPERVIOUS SURFACE AREA FOR SITE = 0.45 AC = 19,772 SF 4. ALLOWABLE FUTURE IMPERVIOUS AREA = 21,344 SF - 19,772 SF = 1,572 SF


1. PAVEMENT MARKINGS WITHIN SITE CAN BE PAINTED. PAVEMENT MARKINGS


1. ALL HC RAMPS TO BE FIELD ADJUSTED WITH INPUT FROM THE TOWN OF ZEBULON FIELD INSPECTOR PRIOR TO INSTALLATION.

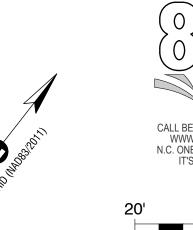


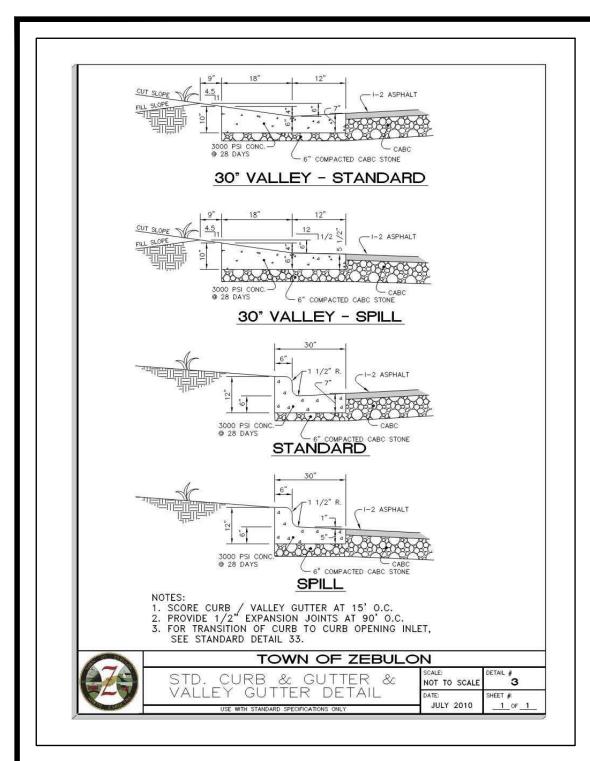


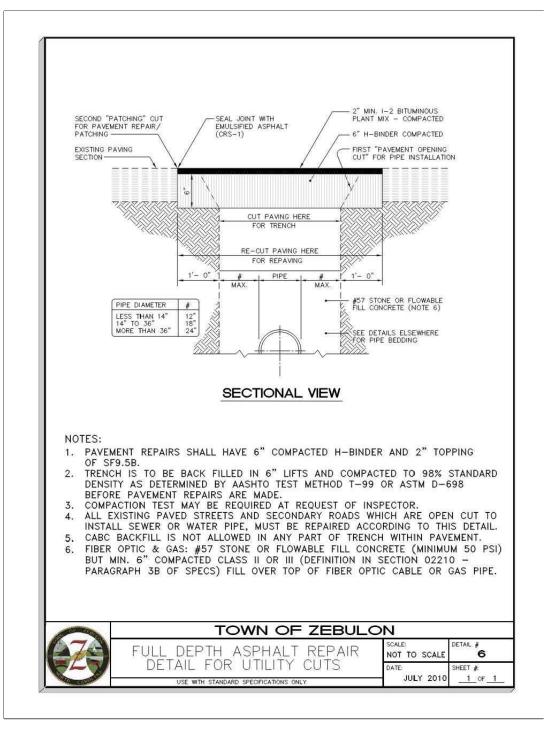


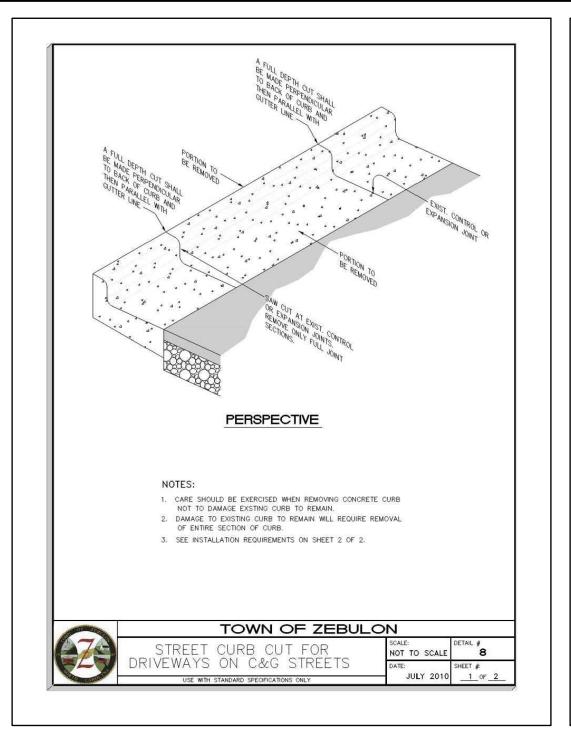


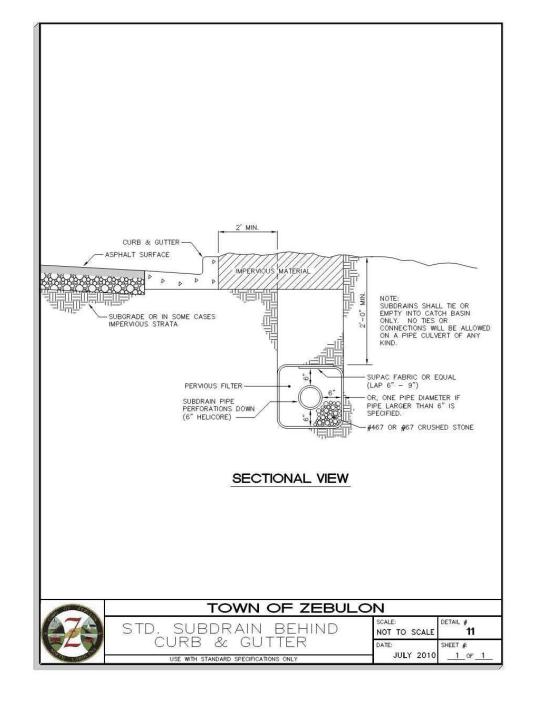


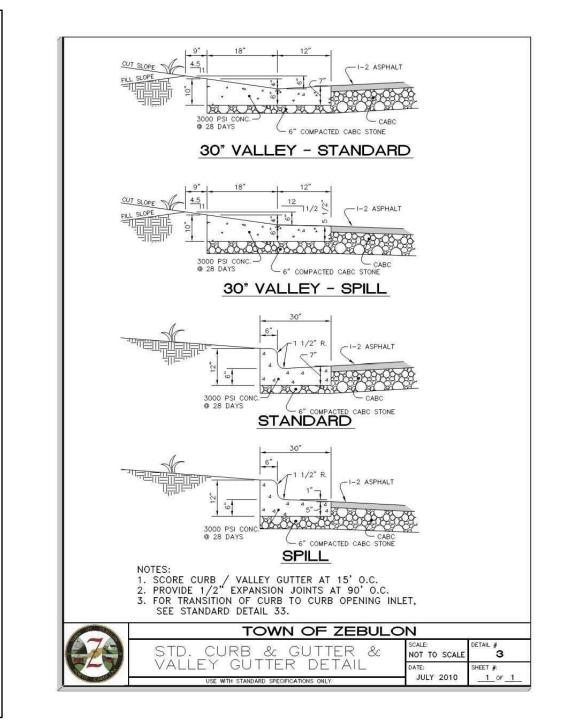


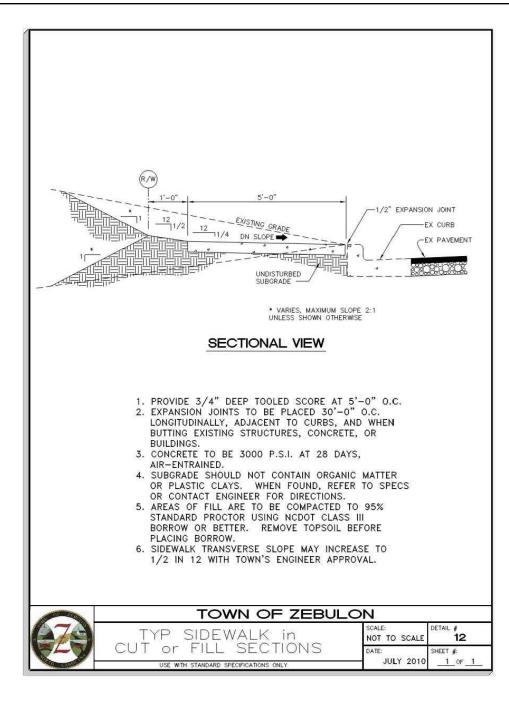


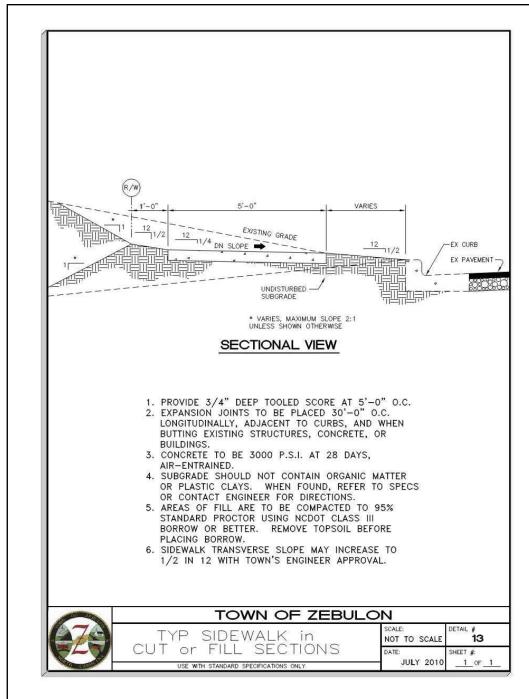


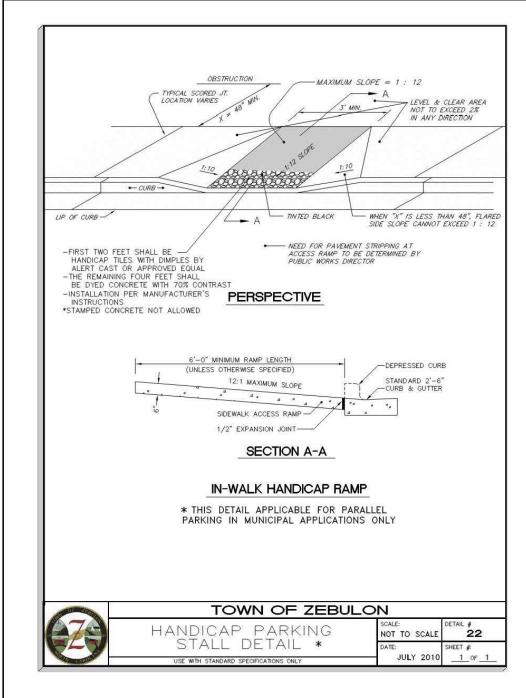


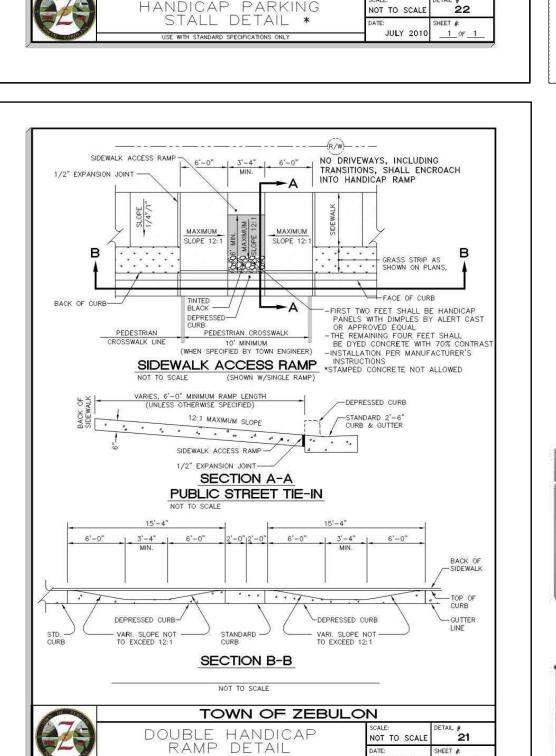

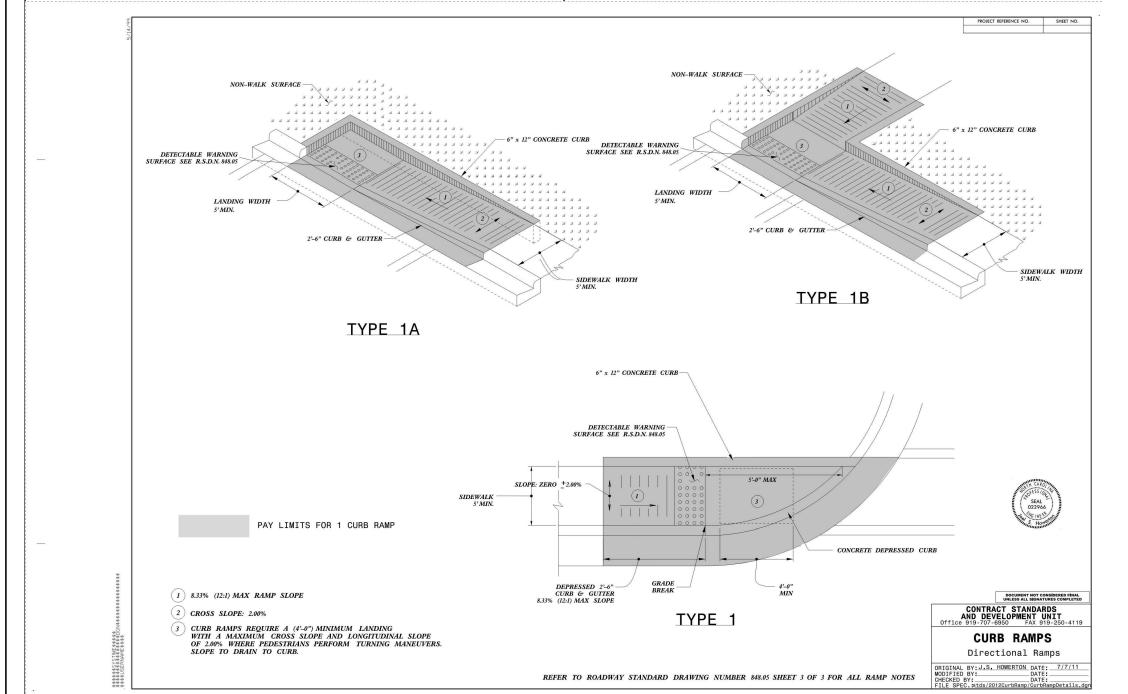

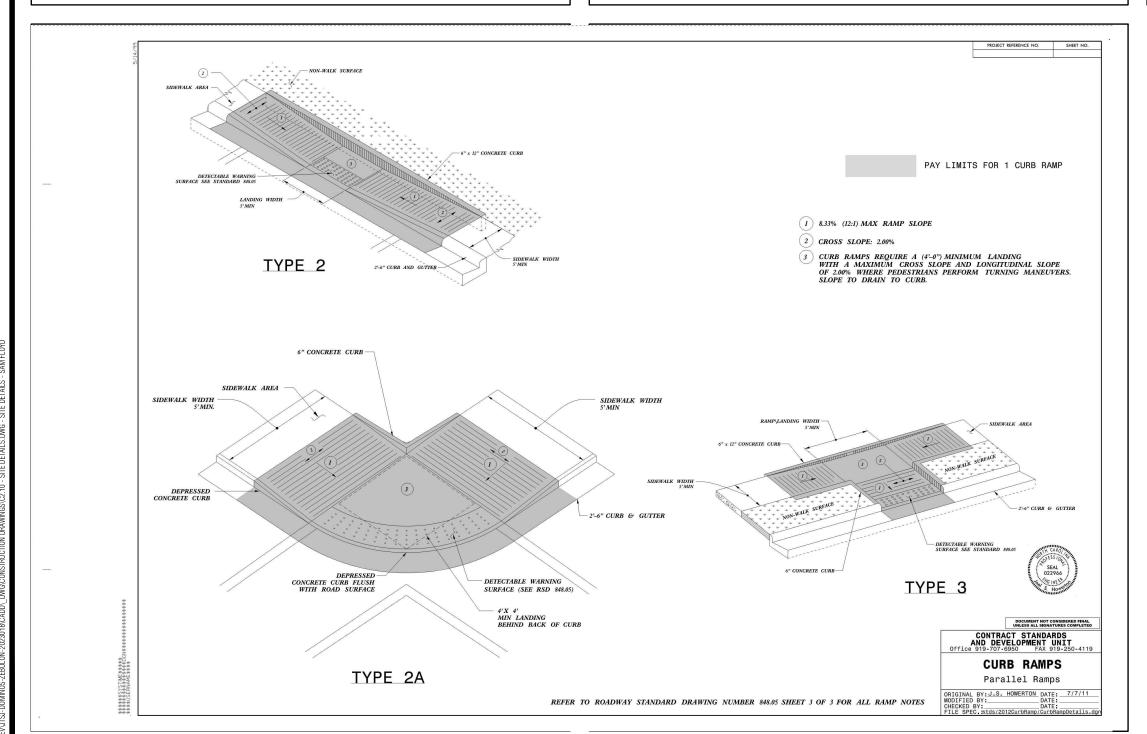

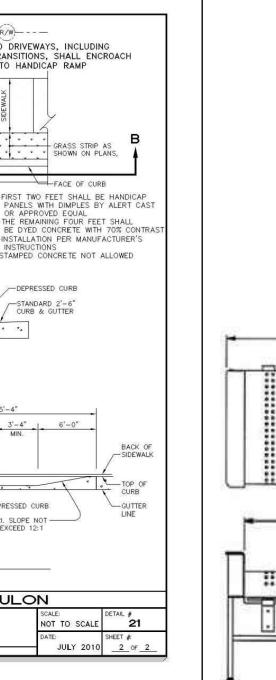

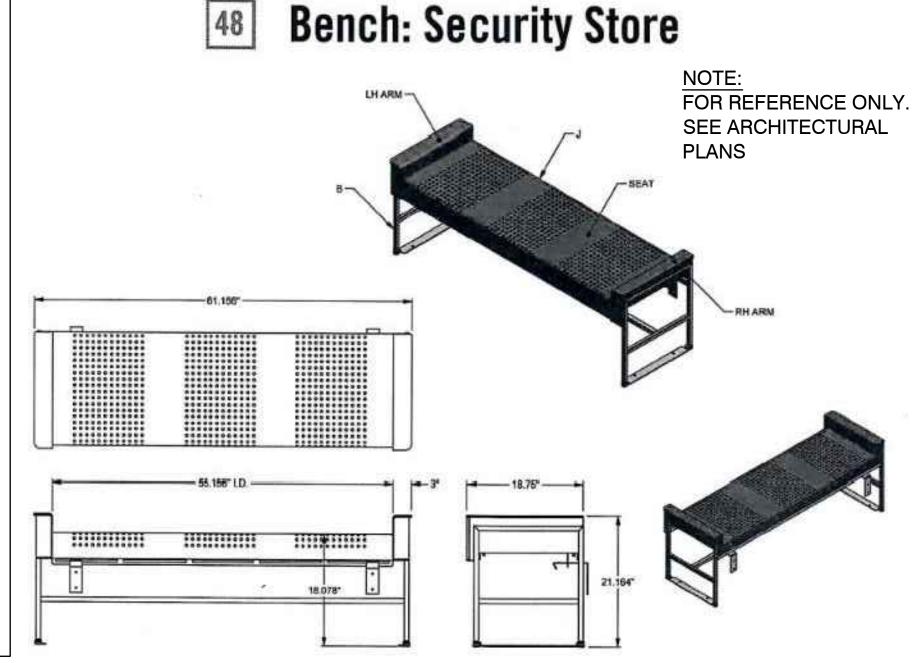



ALL CONSTRUCTION TO BE IN ACCORDANCE WITH TOWN OF ZEBULON, NCDOT & NCDEQ STANDARDS, SPECIFICATIONS AND DETAILS.

N.C. ONE-CALL CENTER IT'S THE LAW!

AS SHOWN

2023018

W-408<sup>-</sup>


**REVISIONS:** 


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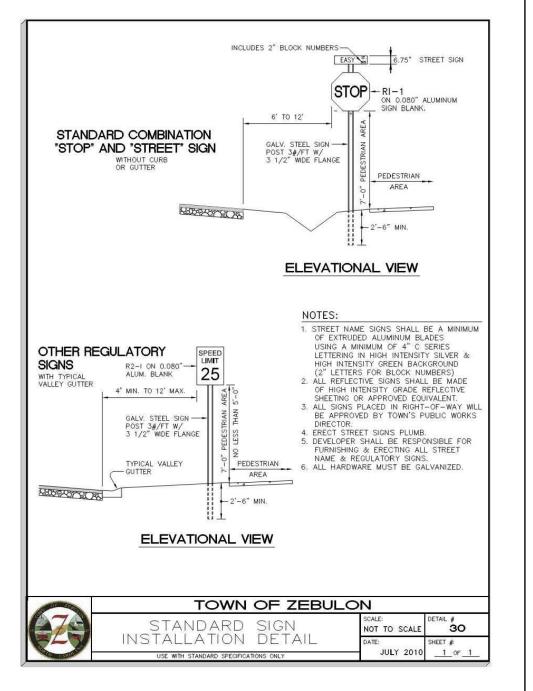
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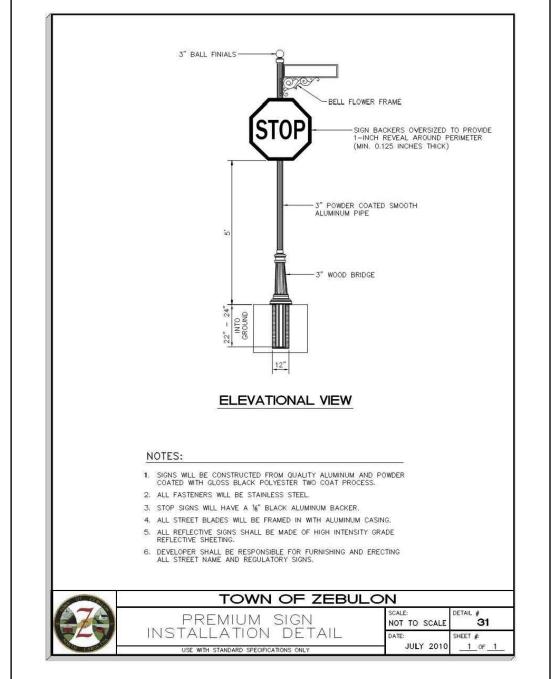
PROJECT No.


RAWING No.







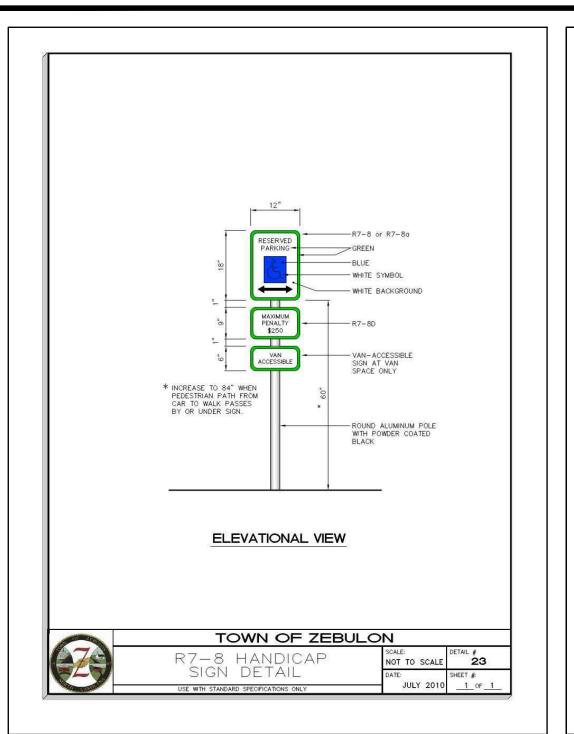

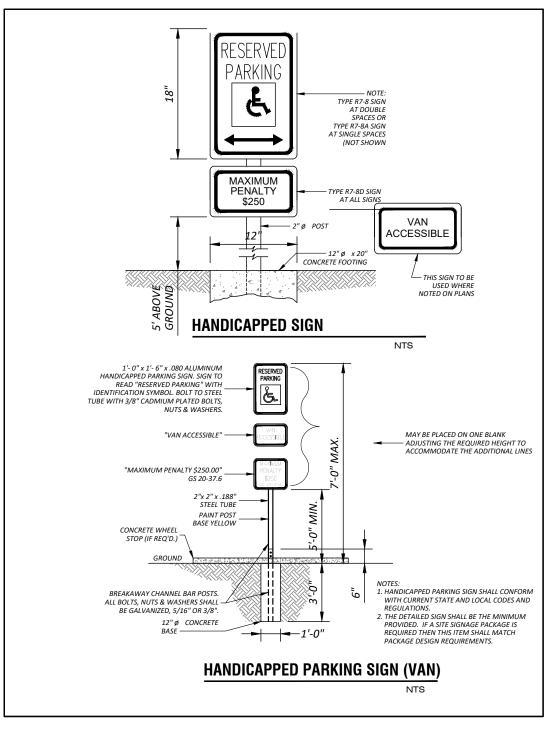

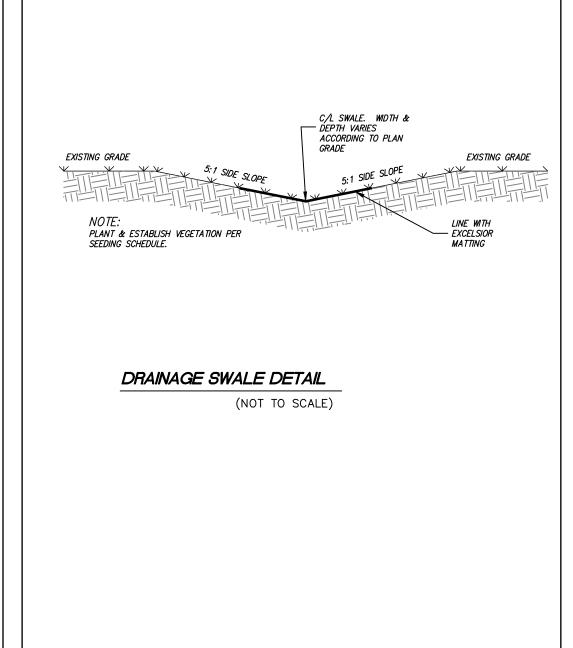


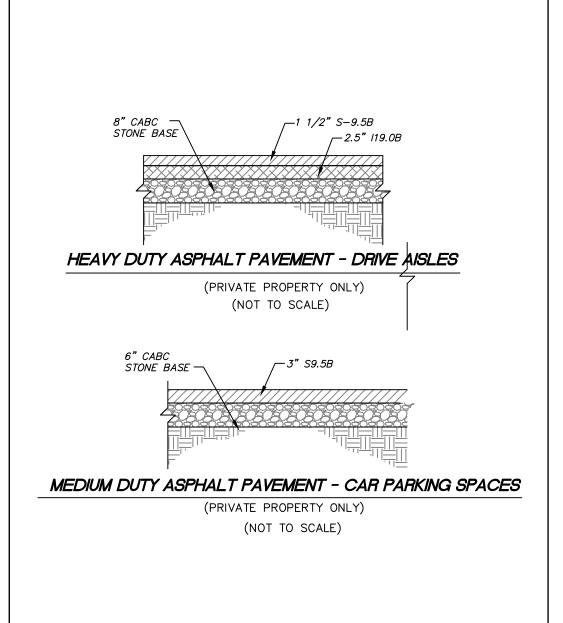


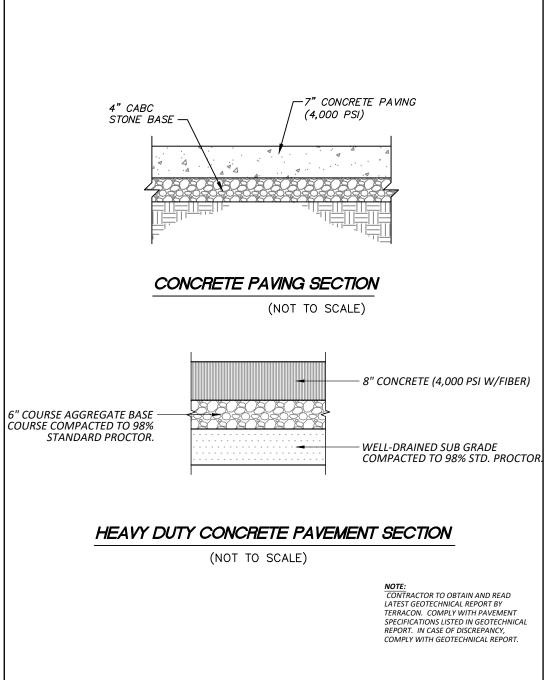



FIELD BEFORE CONSTRUCTION.


**√ 6' HT. DUMPSTER SCREEN WALL** 

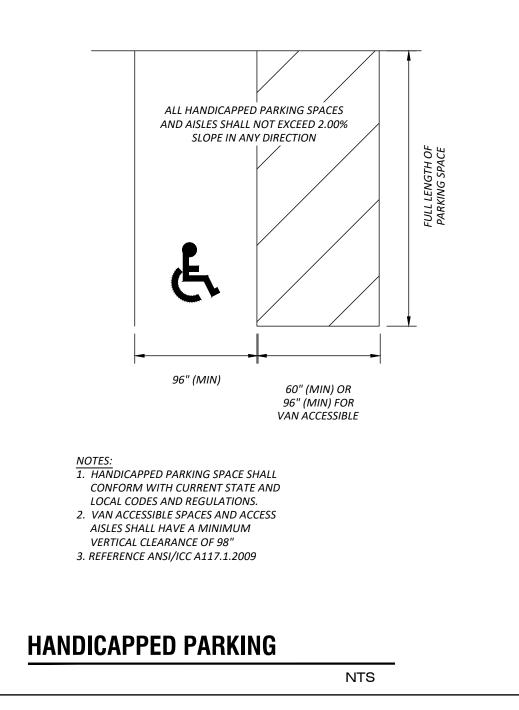

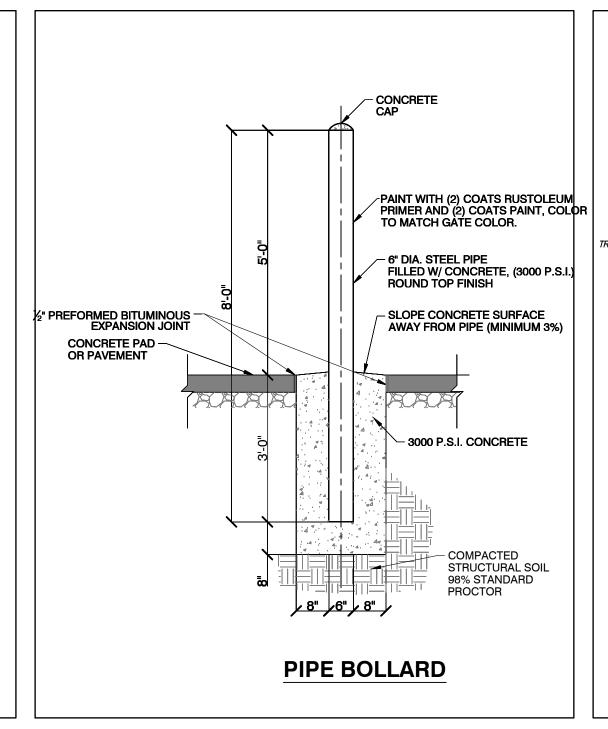


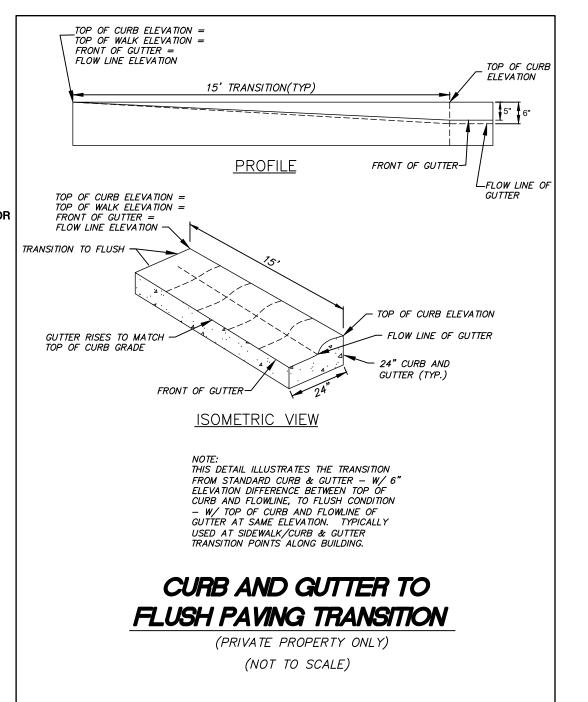

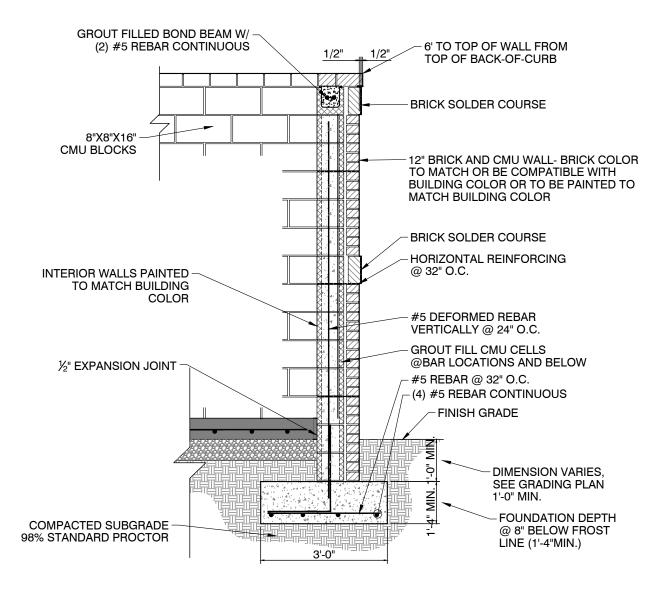

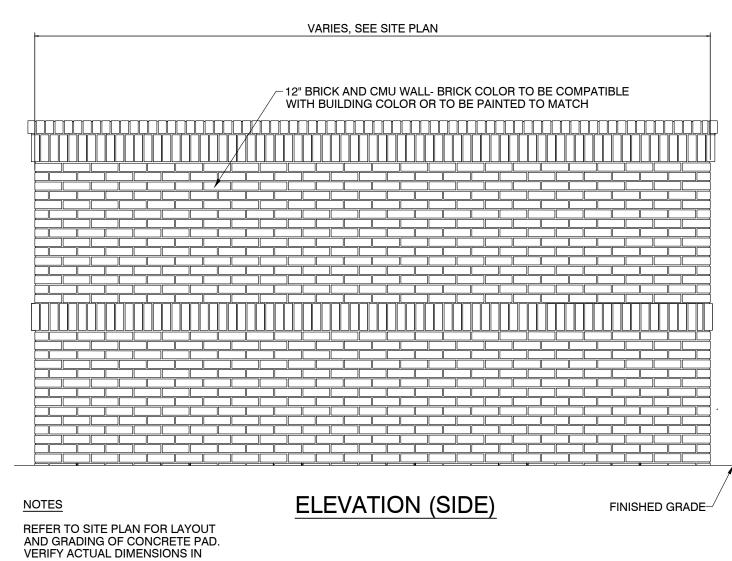

NOTE: THIS TYPICAL WALL DETAIL IS FOR REFERENCE ONLY. THE PROFESSIONAL ENGINEER'S PE SEAL ON THESE PLANS DOES NOT INCLUDE ANY WALL DESIGN. SEE ARCHITECTURAL PLANS FOR SCREEN WALL DESIGN & DETAILS.

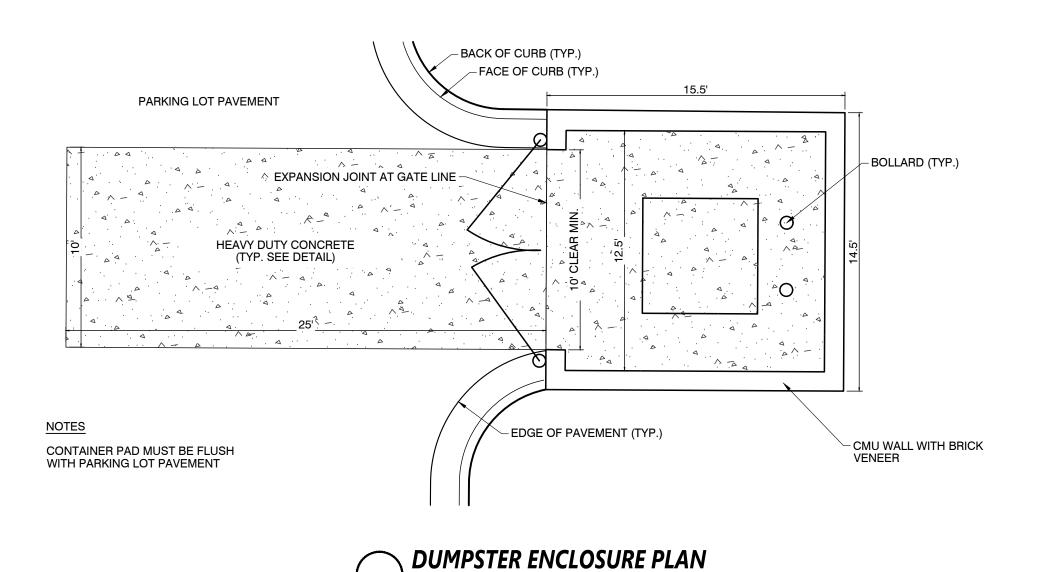



ALL CONSTRUCTION TO BE IN ACCORDANCE WITH TOWN OF ZEBULON, NCDOT & NCDEQ STANDARDS, SPECIFICATIONS AND DETAILS.

DATE:

DESIGNED BY: MS

DRAWN BY: MS

CHECKED BY: JSJ

PROJECT No. 2023018

DRAWING No. W-4081


SCALE: AS SHOWN

SHEFT No.

SHEET NO.

C2.11

**REVISIONS:** 

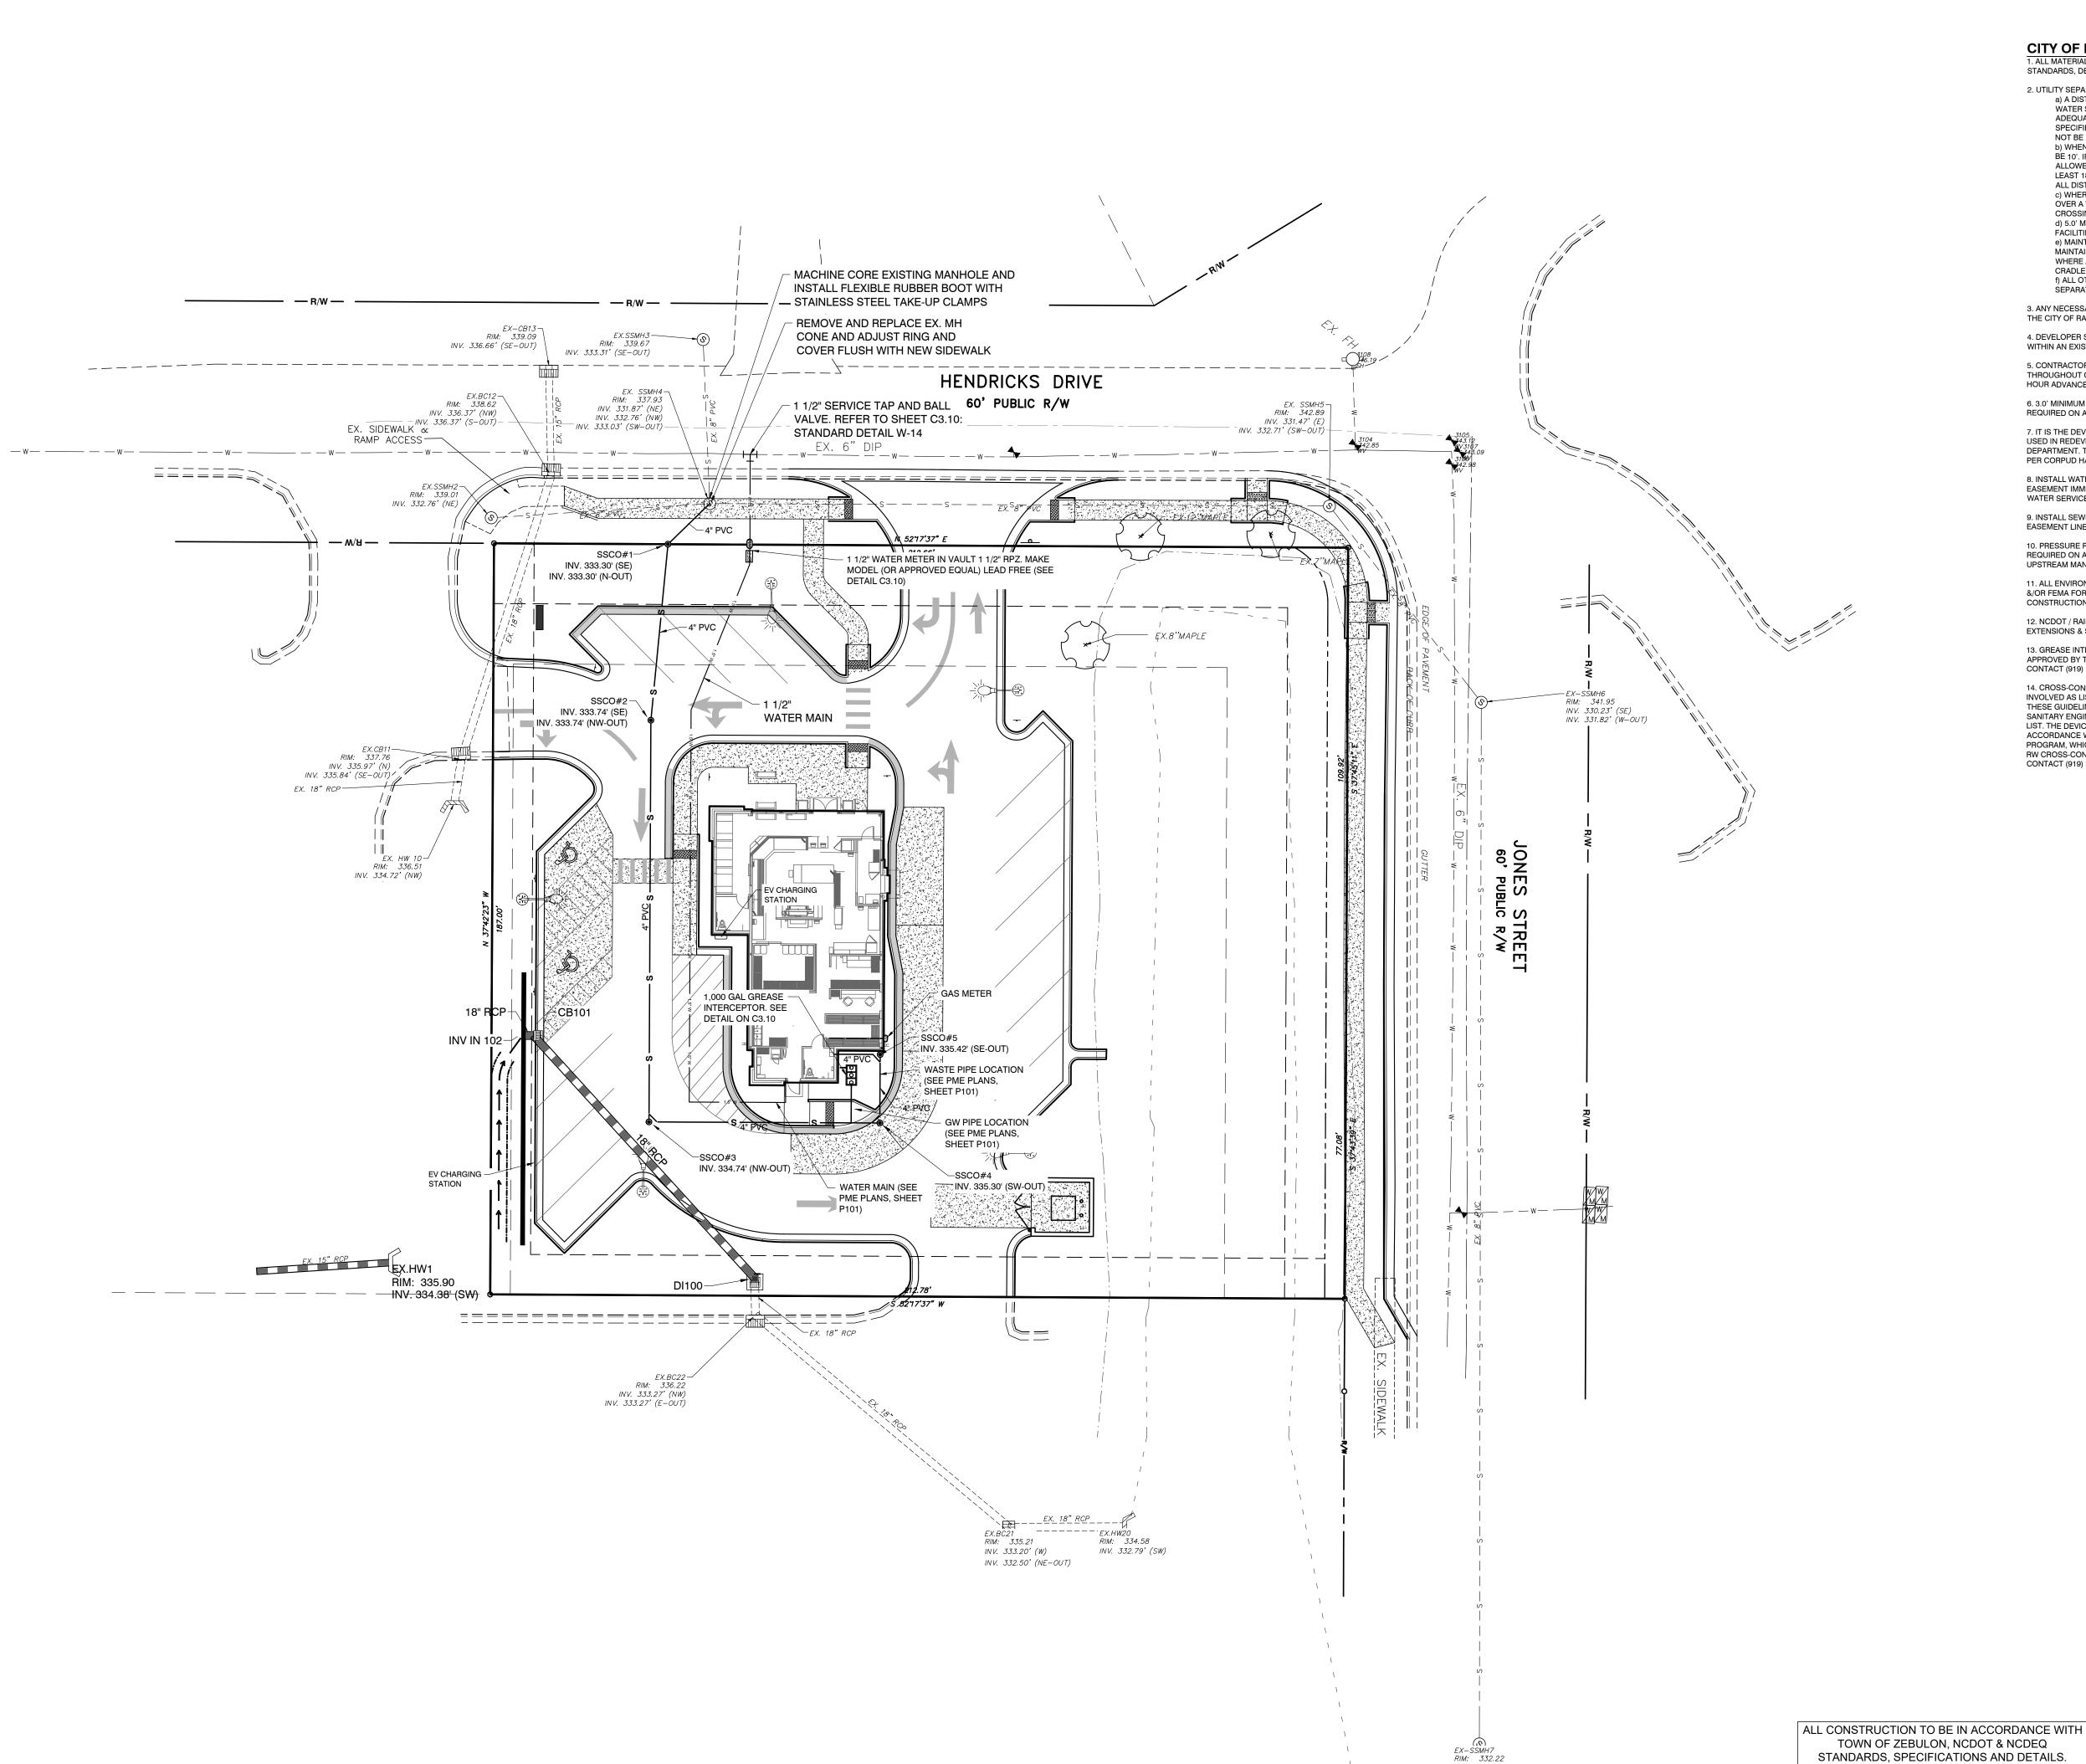

INV. 330.02' (SE) INV. 331.45' (NW-OUT) CITY OF RALEIGH STANDARD UTILITY NOTES (as applicable):

1. ALL MATERIALS & CONSTRUCTION METHODS SHALL BE IN ACCORDANCE WITH CITY OF RALEIGH DESIG STANDARDS, DETAILS & SPECIFICATIONS (REFERENCE: CORPUD HANDBOOK, CURRENT EDITION)

2. UTILITY SEPARATION REQUIREMENTS: a) A DISTANCE OF 100' SHALL BE MAINTAINED BETWEEN SANITARY SEWER & ANY PRIVATE OR PUBLIC WATER SUPPLY SOURCE SUCH AS AN IMPOUNDED RESERVOIR USED AS A SOURCE OF DRINKING WATER. IF ADEQUATE LATERAL SEPARATION CANNOT BE ACHIEVED, FERROUS SANITARY SEWER PIPE SHALL BE SPECIFIED & INSTALLED TO WATERLINE SPECIFICATIONS. HOWEVER, THE MINIMUM SEPARATION SHALL NOT BE LESS THAN 25' FROM A PRIVATE WELL OR 50' FROM A PUBLIC WELL b) WHEN INSTALLING WATER &/OR SEWER MAINS, THE HORIZONTAL SEPARATION BETWEEN UTILITIES SHALL

BE 10'. IF THIS SEPARATION CANNOT BE MAINTAINED DUE TO EXISTING CONDITIONS, THE VARIATION ALLOWED IS THE WATER MAIN IN A SEPARATE TRENCH WITH THE ELEVATION OF THE WATER MAIN AT LEAST 18" ABOVE THE TOP OF THE SEWER & MUST BE APPROVED BY THE PUBLIC UTILITIES DIRECTOR. ALL DISTANCES ARE MEASURED FROM OUTSIDE DIAMETER TO OUTSIDE DIAMETER c) WHERE IT IS IMPOSSIBLE TO OBTAIN PROPER SEPARATION, OR ANYTIME A SANITARY SEWER PASSES OVER A WATERMAIN, DIP MATERIALS OR STEEL ENCASEMENT EXTENDED 10' ON EACH SIDE OF CROSSING MUST BE SPECIFIED & INSTALLED TO WATERLINE SPECIFICATIONS d) 5.0' MINIMUM HORIZONTAL SEPARATION IS REQUIRED BETWEEN ALL SANITARY SEWER & STORM SEWER FACILITIES, UNLESS DIP MATERIAL IS SPECIFIED FOR SANITARY SEWER

e) MAINTAIN 18" MIN. VERTICAL SEPARATION AT ALL WATERMAIN & RCP STORM DRAIN CROSSINGS; MAINTAIN 18" MIN. VERTICAL SEPARATION AT ALL SANITARY SEWER & RCP STORM DRAIN CROSSINGS. WHERE ADEQUATE SEPARATIONS CANNOT BE ACHIEVED, SPECIFY DIP MATERIALS & A CONCRETE CRADLE HAVING 6" MIN. CLEARANCE (PER CORPUD DETAILS W-41 & S-49) f) ALL OTHER UNDERGROUND UTILITIES SHALL CROSS WATER & SEWER FACILITIES WITH 18" MIN. VERTICAL

3. ANY NECESSARY FIELD REVISIONS ARE SUBJECT TO REVIEW & APPROVAL OF AN AMENDED PLAN &/OR PROFILE BY THE CITY OF RALEIGH PUBLIC UTILITIES DEPARTMENT PRIOR TO CONSTRUCTION

4. DEVELOPER SHALL PROVIDE 30 DAYS ADVANCE WRITTEN NOTICE TO OWNER FOR ANY WORK REQUIRED WITHIN AN EXISTING CITY OF RALEIGH UTILITY EASEMENT TRAVERSING PRIVATE PROPERTY

5. CONTRACTOR SHALL MAINTAIN CONTINUOUS WATER & SEWER SERVICE TO EXISTING RESIDENCES & BUSINESSES THROUGHOUT CONSTRUCTION OF PROJECT. ANY NECESSARY SERVICE INTERRUPTIONS SHALL BE PRECEDED BY A 24 HOUR ADVANCE NOTICE TO THE CITY OF RALEIGH PUBLIC UTILITIES DEPARTMENT

7. IT IS THE DEVELOPER'S RESPONSIBILITY TO ABANDON OR REMOVE EXISTING WATER & SEWER SERVICES NOT BEING

6. 3.0' MINIMUM COVER IS REQUIRED ON ALL WATER MAINS & SEWER FORCEMAINS. 4.0' MINIMUM COVER IS REQUIRED ON ALL REUSE MAINS

USED IN REDEVELOPMENT OF A SITE UNLESS OTHERWISE DIRECTED BY THE CITY OF RALEIGH PUBLIC UTILITIES DEPARTMENT. THIS INCLUDES ABANDONING TAP AT MAIN & REMOVAL OF SERVICE FROM ROW OR EASEMENT PER CORPUD HANDBOOK PROCEDURE

8. INSTALL WATER SERVICES WITH METERS LOCATED AT ROW OR WITHIN A 2'X2' WATERLINE EASEMENT IMMEDIATELY ADJACENT. NOTE: IT IS THE APPLICANT'S RESPONSIBILITY TO PROPERLY SIZE THE WATER SERVICE FOR EACH CONNECTION TO PROVIDE ADEQUATE FLOW & PRESSURE

9. INSTALL SEWER SERVICES @ 1.0% MINIMUM GRADE WITH CLEANOUTS LOCATED AT ROW OR EASEMENT LINE & SPACED EVERY 75 LINEAR FEET MAXIMUM

10. PRESSURE REDUCING VALVES ARE REQUIRED ON ALL WATER SERVICES EXCEEDING 80 PSI; BACKWATER VALVES ARE REQUIRED ON ALL SANITARY SEWER SERVICES HAVING BUILDING DRAINS LOWER THAN 1.0' ABOVE THE NEXT

11. ALL ENVIRONMENTAL PERMITS APPLICABLE TO THE PROJECT MUST BE OBTAINED FROM NCDWQ, USACE &/OR FEMA FOR ANY RIPARIAN BUFFER, WETLAND &/OR FLOODPLAIN IMPACTS (RESPECTIVELY) PRIOR TO CONSTRUCTION.

12. NCDOT / RAILROAD ENCROACHMENT AGREEMENTS ARE REQUIRED FOR ANY UTILITY WORK (INCLUDING MAIN EXTENSIONS & SERVICE TAPS) WITHIN STATE OR RAILROAD ROW PRIOR TO CONSTRUCTION

13. GREASE INTERCEPTOR / OIL WATER SEPARATOR SIZING CALCULATIONS & INSTALLATION SPECIFICATIONS SHALL BE APPROVED BY THE RW FOG PROGRAM COORDINATOR PRIOR TO ISSUANCE OF A UC / BUILDING PERMIT. CONTACT (919) 996-4516 OR FOG@RALEIGHNC.GOV FOR MORE INFORMATION.

14. CROSS-CONNECTION CONTROL PROTECTION DEVICES ARE REQUIRED BASED ON DEGREE OF HEALTH HAZARD INVOLVED AS LISTED IN APPENDIX-B OF THE RULES GOVERNING PUBLIC WATER SYSTEMS IN NORTH CAROLINA. THESE GUIDELINES ARE THE MINIMUM REQUIREMENTS. THE DEVICES SHALL MEET AMERICAN SOCIETY OF SANITARY ENGINEERING (ASSE) STANDARDS OR BE ON THE UNIVERSITY OF SOUTHERN CALIFORNIA APPROVAL LIST. THE DEVICES SHALL BE INSTALLED AND TESTED (BOTH INITIAL AND PERIODIC TESTING THEREAFTER) IN ACCORDANCE WITH THE MANUFACTURER'S RECOMMENDATIONS OR THE LOCAL CROSS-CONNECTION CONTROL PROGRAM, WHICHEVER IS MORE STRINGENT. A CERTIFICATE OF COMPLIANCE SHALL ALSO BE OBTAINED FROM THE RW CROSS-CONNECTION COORDINATOR FOR EACH DEVICE PRIOR TO ISSUANCE OF A UC / BUILDING PERMIT. CONTACT (919) 996-5923 OR CROSS.CONNECTION@RALEIGHNC.GOV FOR MORE INFORMATION.

## **NOTES:**

- 1. BOUNDARY, TOPOGRAPHIC AND PLANIMETRIC FEATURES SHOWN ARE FROM A FIELD SURVEY PERFORMED BY WILLIAMS - PEARCE & ASSOC., P.A. PROFESSIONAL LAND SURVEYORS P.O. BOX 892, ZEBULON, N.C. 27597 PHONE (919) 269-9605 PROPERTY SURVEY FOR: PIEDMONT PROPERTIES ON 12/06/2022.
- 2. PER FEMA FIRM MAP 3720466000L DATED 7/7/14, THIS PROJECT IS IN ZONE X AND THEREFORE THERE IS NO REGULATORY FLOODPLAIN LOCATED ON THIS PROPERTY.
- 3. WETLANDS, STREAMS & ASSOCIATED BUFFERS TO BE DETERMINED.

## ATTENTION CONTRACTORS

The Construction Contractor responsible for the extension of water, sewer, and/or reuse, as approved in these plans, is responsible for contacting the Public Utilities Department at (919) 996-4540 at least twenty four hours prior to beginning any of their construction.

Failure to notify both City Departments in advance of beginning construction, will result in the issuance of *monetary fines*, and require reinstallation of any water or sewer facilities not inspected as a result of this notification failure.

Failure to call for Inspection, Install a Downstream Plug, have Permitted Plans on the Jobsite, or any other Violation of City of Raleigh Standards will result in a Fine and Possible Exclusion from future work in the City of Raleigh.






SCALE 1 inch = 20 ft

DRAWN BY: CHECKED BY: 2023018 PROJECT No. W-408<sup>-</sup> DRAWING No. AS SHOWN

**REVISIONS:** 

JSJ/MS DESIGNED BY:

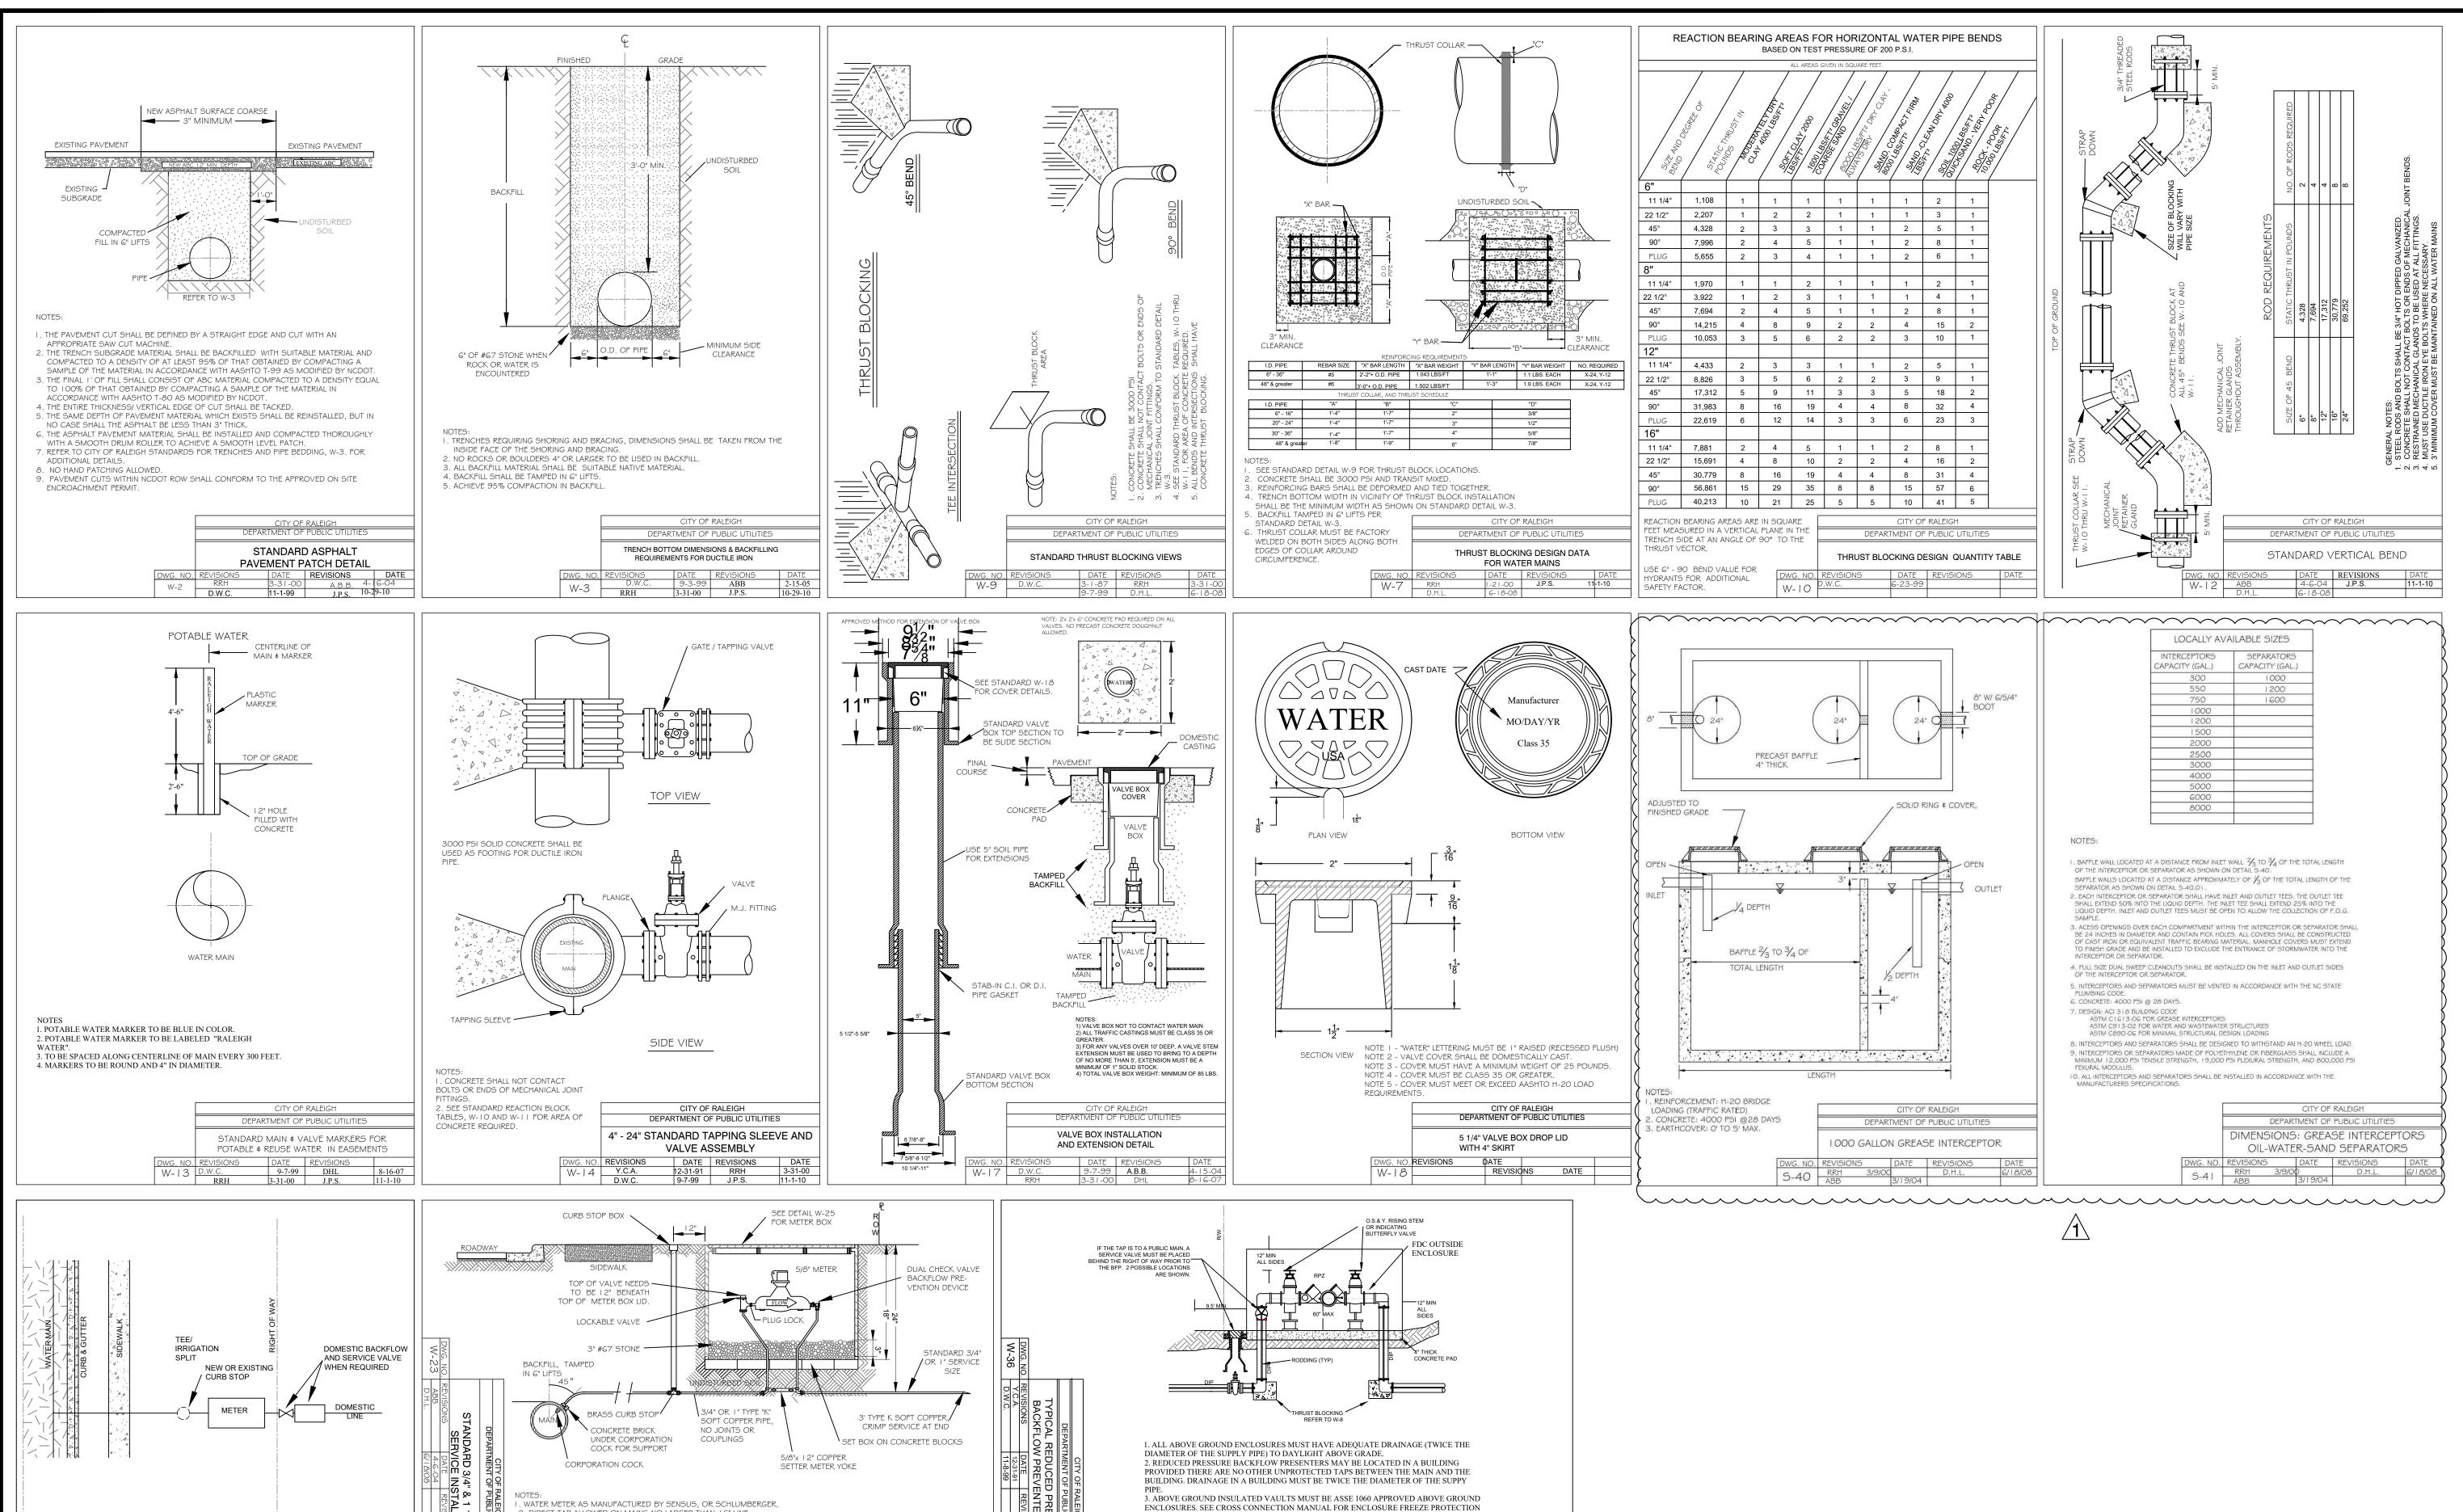

AND CERTIFICATION REQUIREMENTS.

6. FOR ENCLOSURE DIMENSIONS SEE DETAIL W-34.

PROTECTED FROM FROST.

4. RESIDENTIAL LAWN IRRIGATION R.P. ASSEMBLIES THAT ARE REMOVED TO PREVENT

FREEZING IN THE WINTER MONTHS MUST BE CAPPED OFF. ALL ABOVE GROUND

ASSEMBLIES, EXCEPT RESIDENTIAL LAWN IRRIGATION ASSEMBLIES, MUST BE

7. STEEL RODS AND BOLTS SHALL BE 3/4" HOT DIPPED GALVANIZED.

8. ALL ASSEMBLIES MUST BE ON THE CURRENT APPROVAL LIST.

2. DIRECT TAP ALLOWED ON MAINS NO LARGER THAN 16" LINE,

EASEMENT ADJACENT TO R.W.

CURB STOP OPERATION.

1. IRRIGATION METER SHALL BE LOCATED ON THE SIDE OF DOMESTIC METER WITH

. THE BACKFLOW SHALL BE INSTALLED NO MORE THAN 10' FROM THE METER IN A

4. A SERVICE VALVE IS REQUIRED AFTER THE METER BUT BEFORE THE BACKFLOW ASSEMBLY FOR MAINTENANCE AND REPLACEMENT PURPOSES.
5. THE INSTALLATION MUST ALSO MEET ALL CODE REQUIREMENTS PER THE NC

3. THE RP RELIEF VALVE SHALL BE A MINIMUM OF 12" ABOVE ANY MATERIAL (MULCH

CITY OF RALEIGH

DEPARTMENT OF PUBLIC UTILITIES IRRIGATION TAP ON NEW AND EXISTING SERVICES

3. BACKFLOW RISER/STANDPIPE SHALL BE OF COPPER OR BRASS.

INCREASING ADDRESSES.

VISIBLE LOCATION.

INCLUDED) OR GRADE.

PLUMBING CODE.

3. METER BOX TO BE LOCATED IN R/W ADJACENT TO PROPERTY OR IN APPROVED

4. WHEN THE GRADE CHANGES ON EXISTING SERVICES, A COPPER RESETTER CAN BE

USED TO ADJUST TO GRADE. COPPER RESETTERS ARE PROHIBITED ON NEW SERVICES.

UPPER SECTION, AND ARCH STYLE BASE. STEEL STATIONARY ROD TO BE PROVIDED FOR

5. CURB STOP BOX SHALL HAVE PLUG STYLE LID WITH PENTAGON BOLT. I-I/4" STEEL

ALL CONSTRUCTION TO BE IN ACCORDANCE WITH TOWN OF ZEBULON, NCDOT & NCDEQ STANDARDS, SPECIFICATIONS AND DETAILS.




**REVISIONS:** 

CONSTRUCTION DRAWINGS SUBMITTAL #2	12/07/23	
LIENT REVIEW	11/21/23	
IRC REVIEW PLAN	11/07/23	
CONSTRUCTION DRAWINGS SUBMITTAL #1	06/01/23	
DESCRIPTION	DATE BY	ВУ

DESIGNED BY:


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DEPARTMENT OF PUBLIC UTILITIES

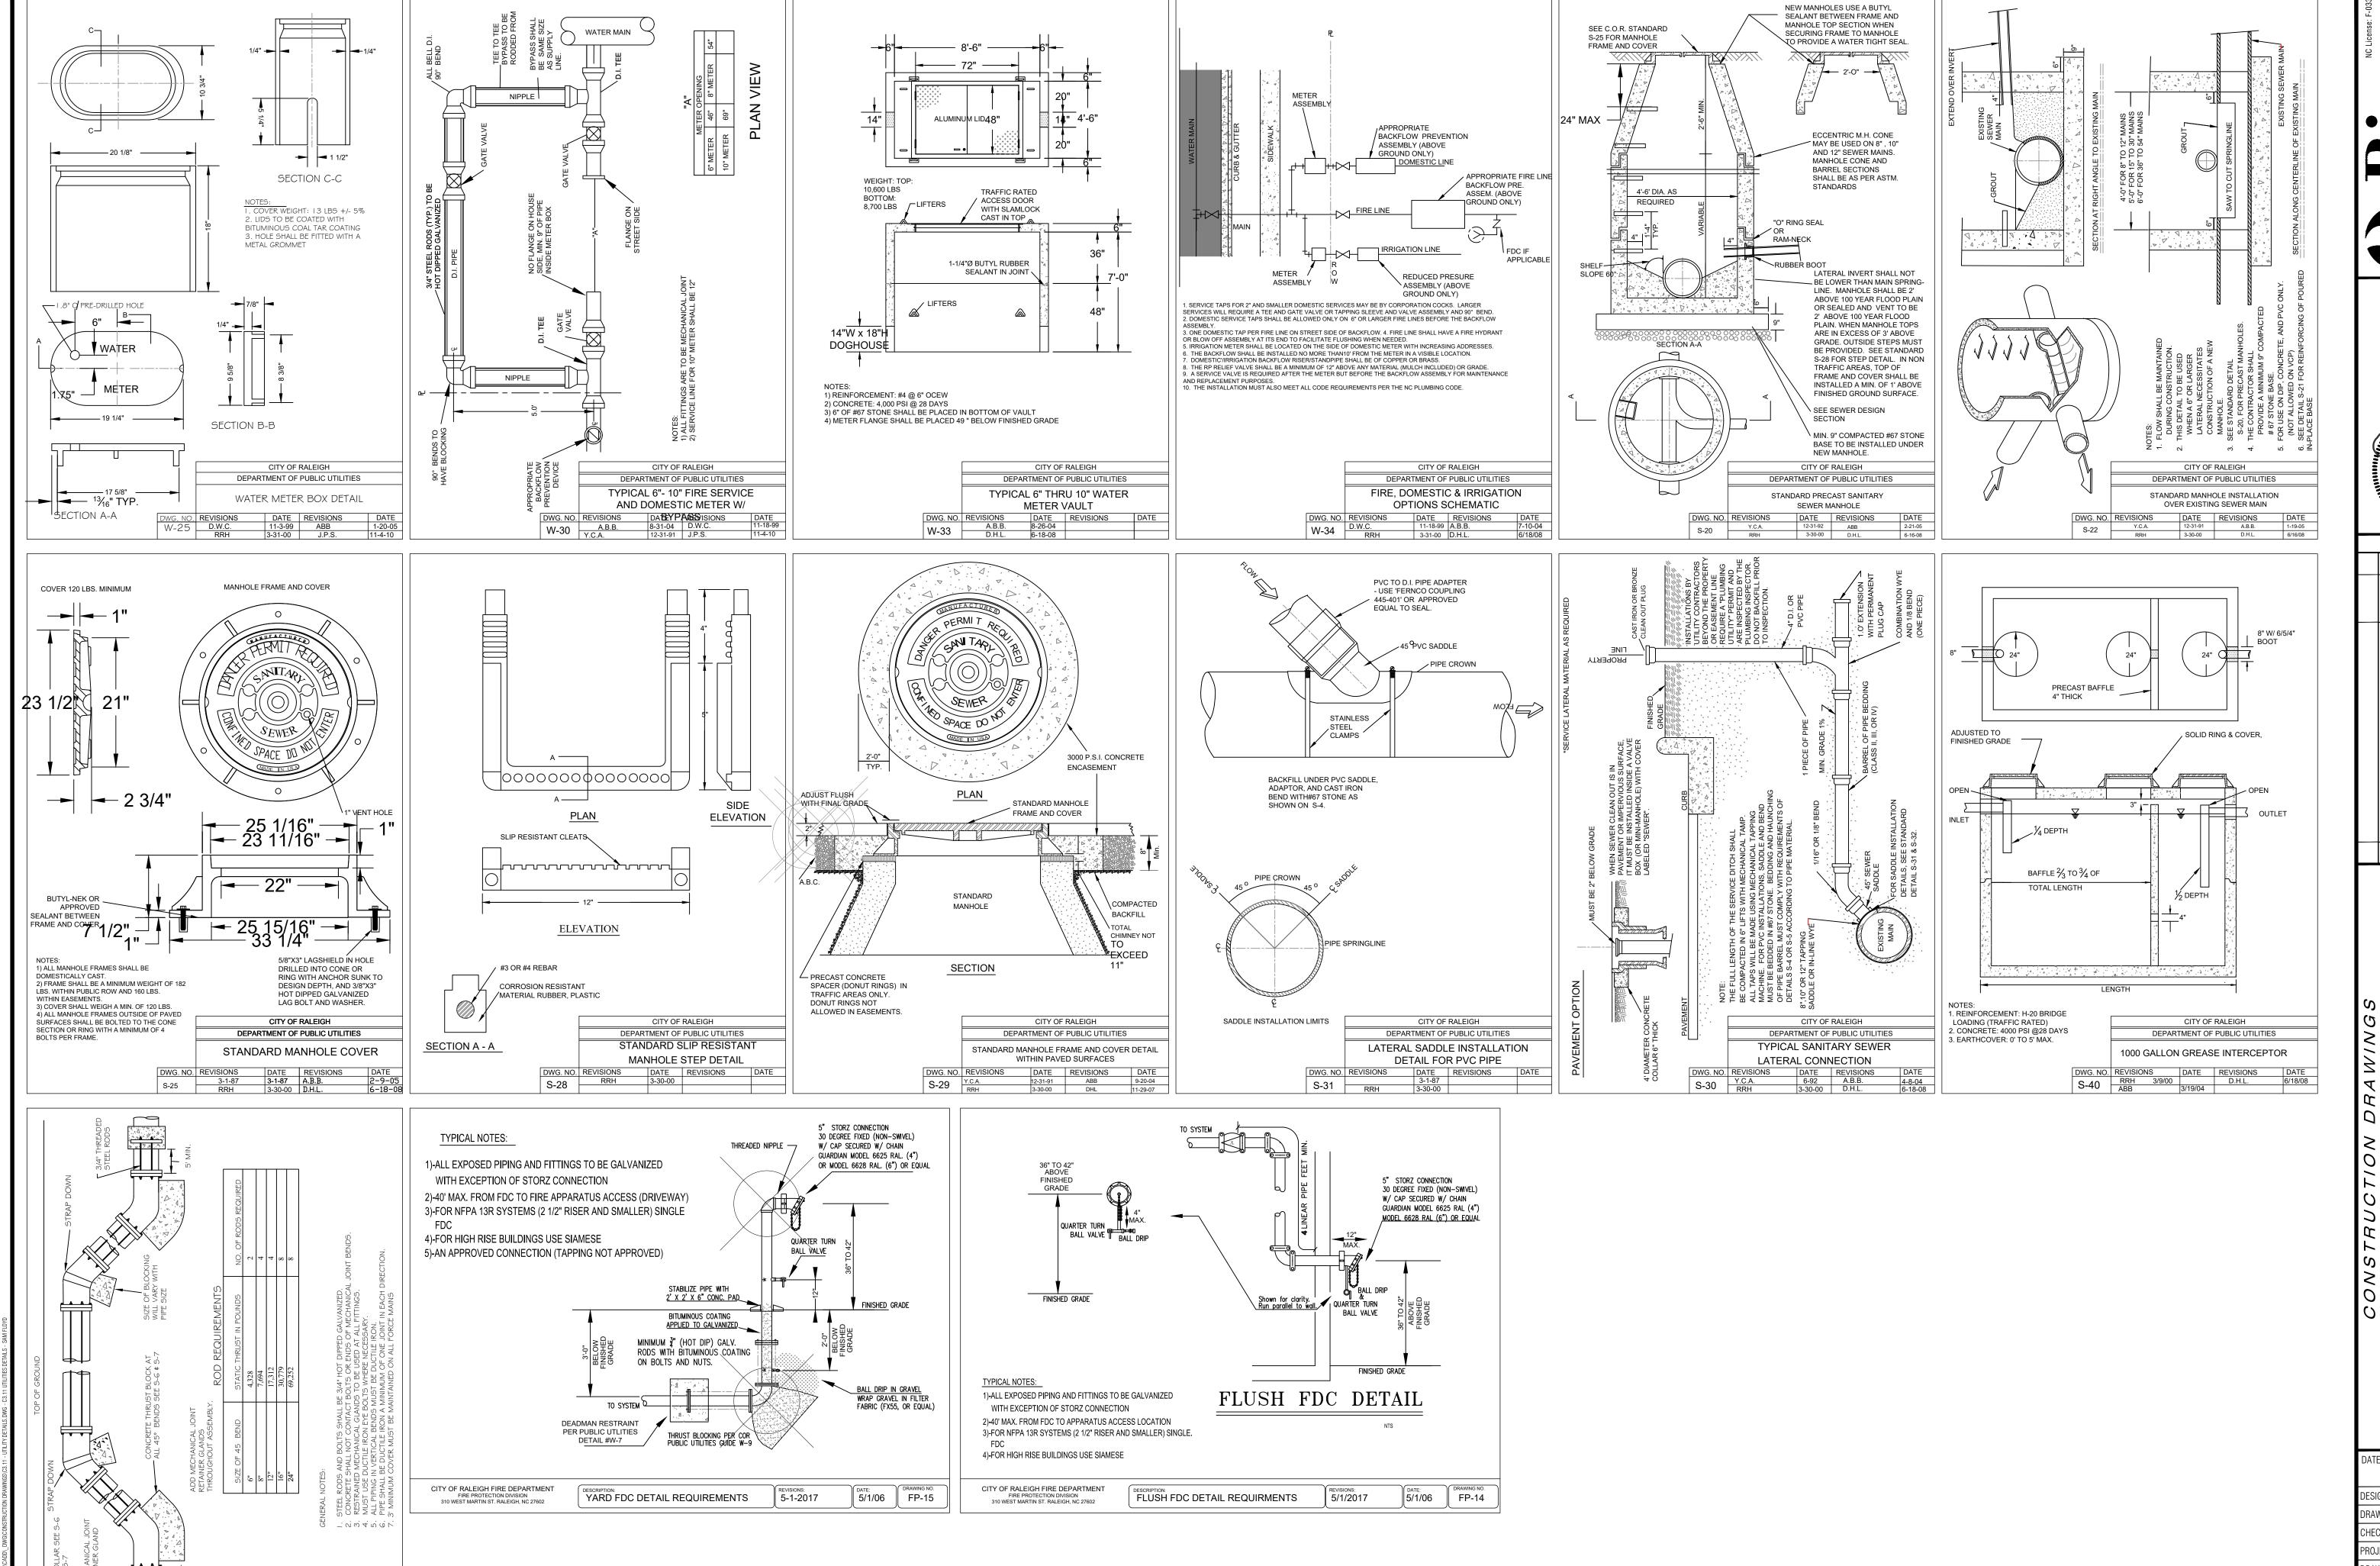STANDARD VERTICAL BEND

ALL CONSTRUCTION TO BE IN ACCORDANCE WITH TOWN OF ZEBULON, NCDOT & NCDEQ STANDARDS, SPECIFICATIONS AND DETAILS.



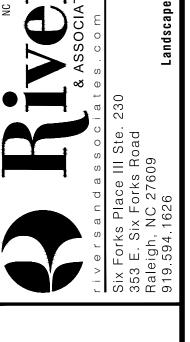


**REVISIONS:** 

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RAWN BY:	MS
HECKED BY:	JSJ
ROJECT No.	2023018
RAWING No.	W-4081
CALE:	AS SHOWN
SHEET No.	

C3.11

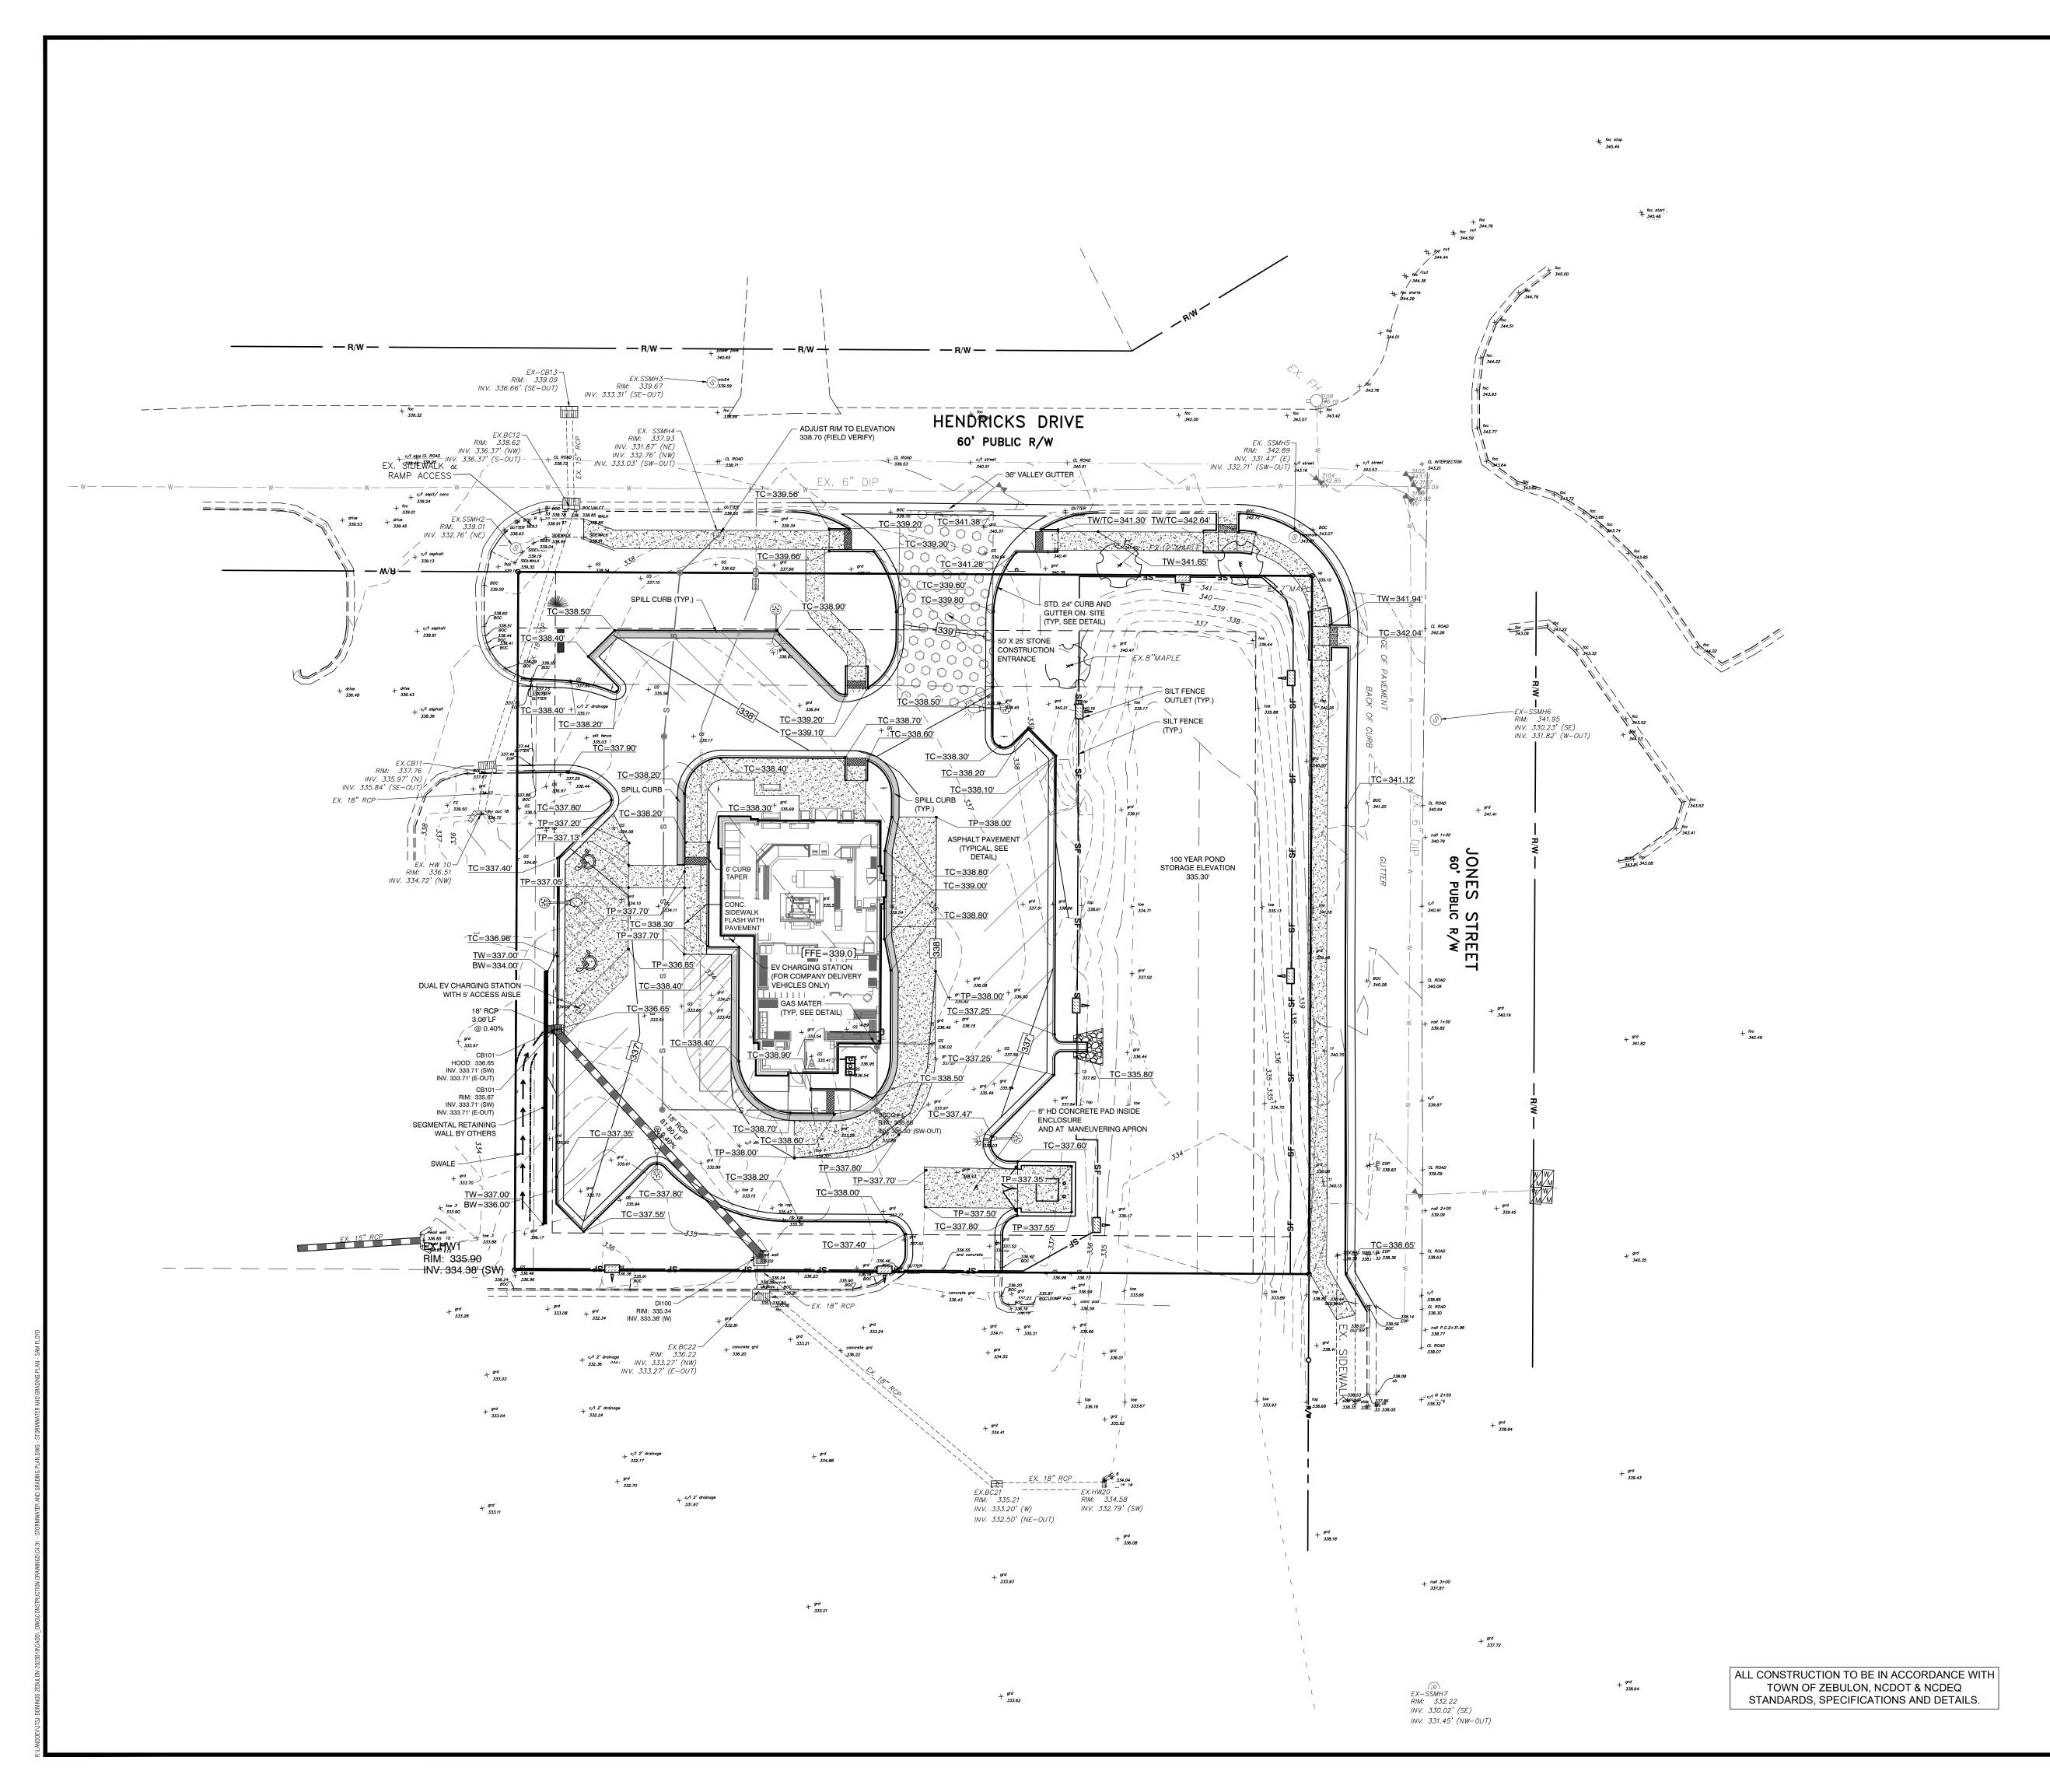

GENERAL NOTES:

1. CONTRACTOR IS RESPONSIBLE FOR INSTALLING AND MAINTAINING A CONSTRUCTION ACCESS ROAD A MINIMUM OF 20' WIDE FROM THE EXISTING PAVEMENT TO THE SITE ENTRANCE. INSTALL A MINIMUM

DEPTH OF 8" CABC. BASE BID SHALL INCLUDE TOTAL OF 3' OF STRIPPING AND UNDERCUT FROM EXISTING GRADE IN PREPARATION OF SITE. THE AREA UNCUT SHALL EXTEND TO THE LIMITS OF DISTURBANCE WITHIN THE BOUNDARY OF THE PROPERTY TO THE PROPOSED RIGHT OF WAY.

3. PRIOR TO PLACING FILL, EXISTING VEGETATION AND ROOT MAT SHOULD BE REMOVED. AREA BELOW THE BASE BID LIMITS SHALL BE FIELD MEASURED AND IDENTIFIED AS UNDERCUT.

4. BASE BID SHALL INCLUDE STRIPPING DEPTHS UP TO 3 FEET TO REMOVE ORGANICS ASSOCIATED WITH THE CLEAR-CUT STUMPS. STUMP HOLES SHOULD BE ENLARGED, SOMEWHAT LEVELED UP AND BACKFILLED WITH COMPACTED FILL. AREAS MAY NEED TO HAVE A NON-WOVEN GEOSYNTHETIC FABRIC INSTALLED AT THE DIRECTION OF THE GEOTECHNICAL ENGINEER WHERE ADDITIONAL UNDERCUT AND BACKFILL WILL NOT BRIDGE THE EXCAVATION 5. AFTER STRIPPING, UNDERCUTTING, INSTALLING NON-WOVEN

GEOSYNTHETIC, AND PRIOR TO PLACING FILL, THE EXPOSED SUBGRADE SOILS IN THE PAVEMENT FOOTPRINTS SHOULD BE COMPACTED/DENSIFIED IN PLACE USING A MEDIUM WEIGHT VIBRATORY ROLLER. THE PURPOSE OF THE VIBRATORY ROLLING IS TO COMPACT/DENSIFY THE EXPOSED SUBGRADE SOILS FOR PAVEMENT SUPPORT. THE ROLLER SHOULD MAKE AT LEAST SIX PASSES ACROSS THE SITE AND PROPOSED DRIVE, WITH THE SECOND SET OF THREE PASSES PERPENDICULAR TO THE FIRST SET OF THREE PASSES ON THE SITE. IF WATER IS BROUGHT TO THE SURFACE BY THE VIBRATORY ROLLING, THE OPERATION SHOULD BE DISCONTINUED UNTIL THE WATER SUBSIDES. VIBRATORY ROLLING SHOULD BE COMPLETED DURING DRY WEATHER. AFTER THE VIBRATORY ROLLING, PORE PRESSURES SHOULD BE ALLOWED TO DISSIPATE FOR A MINIMUM OF 16 HOURS.

6. AFTER THE WAITING PERIOD, PROOFROLLING SHOULD BE PERFORMED ON THE EXPOSED SUBGRADE SOILS IN AREAS TO RECEIVE FILL OR AT THE DESIGN GRADE WITH A FULLY LOADED, TANDEM-AXLE DUMP TRUCK OR SIMILAR RUBBER- TIRED CONSTRUCTION EQUIPMENT (20-TON MINIMUM). PROOFROLLING IS RECOMMENDED AS A MEANS OF DETECTING AREAS OF SOFT OR UNSTABLE SUBGRADE SOILS. THE PROOFROLLING SHOULD BE PERFORMED DURING A PERIOD OF DRY WEATHER TO AVOID DEGRADING AN OTHERWISE SUITABLE SUBGRADE.


7. A NON-WOVEN GEOSYNTHETIC IS TO BE USED AT THIS SITE. AFTER INSTALLING THE GEOSYNTHETIC, LOOSE FILL SHOULD BE DUMPED ONTO THE GEOSYNTHETIC AND SPREAD WITH TRACK/LOW GROUND PRESSURE EQUIPMENT THAT WILL NOT DAMAGE THE NON-WOVEN GEOSYNTHETIC. NO WHEEL OR TRACK TRAFFIC SHOULD OPERATE DIRECTLY ON THE GEOSYNTHETIC. THE INITIAL LIFT SHOULD BE LOOSE AND 10 TO 12 INCHES THICK. CONSTRUCTION TRAFFIC MAY OPERATE ON TOP OF THE FILL LAYER. THE NON-WOVEN GEOSYNTHETIC SHALL HAVE A TENSIL STRENGTH OF 180 LBS AND AN ELONGATION AT THE BREAK OF 50%. IT SHALL HAVE A MULLEN BURST OF 330 PSI AND HAVE A PERMITTIVITY OF 1.4 SEC<sup>-1</sup>.

8. IT IS IMPORTANT TO NOTE THAT THE USE OF RUBBER-TIRED TRAFFIC, SUCH AS LULLS, MAY IMPACT THE PREPARED SUBGRADE SOILS LEADING TO REQUIRED RE-GRADING. WE RECOMMEND THAT THE USE OF RUBBER-TIRED TRAFFIC BE LIMITED TO THE PREPARED SUBGRADES OR THAT THE STABILIZED AREA BE PREPARED FOR SUCH

1. MAXIMUM DENSITY AND OPTIMUM WATER CONTENT AS DETERMINED BY THE STANDARD PROCTOR TEST (ASTM D 698).

2. HIGH PLASTICITY COHESIVE FILL SHOULD NOT BE COMPACTED TO

MORE THAN 100% OF ST	ANDARD PROCTOR MAXIN	MUM DRY DENSITY.
EXISTING		PROPOSED
	PROPERTY LINE	
	—ADJ. PROPERTY LINE	
	<ul> <li>RIGHT OF WAY</li> </ul>	
——————————————————————————————————————	<ul><li>MAJOR TOPO</li></ul>	<del></del>
— — — <i>159</i> — — —	<ul><li>MINOR TOPO</li></ul>	<del></del>
	TREE LINE	~~~~
	—DITCH CENTERLINE	<u></u>
	- TOP OF DITCH	<del></del>
	REINF. CONC. PIPE	
	GRADE BREAK	
	SLOPE ARROW	-1.1%
	SPOT ELEVATION	■ EOP 162.80
	CONCRETE	
	FUTURE ROAD	F
	RIP RAP	
	SPILL CURB	
	CATCH BASIN	
	DROP INLET	
	SILT FENCE	sF
	SILT FENCE OUTLET	7

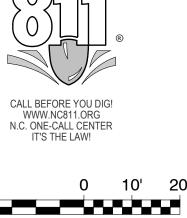

SCALE 1 inch = 20 ft


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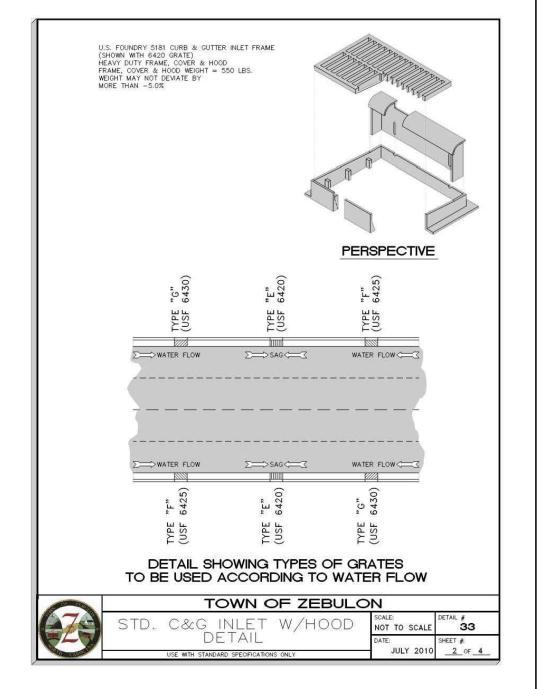
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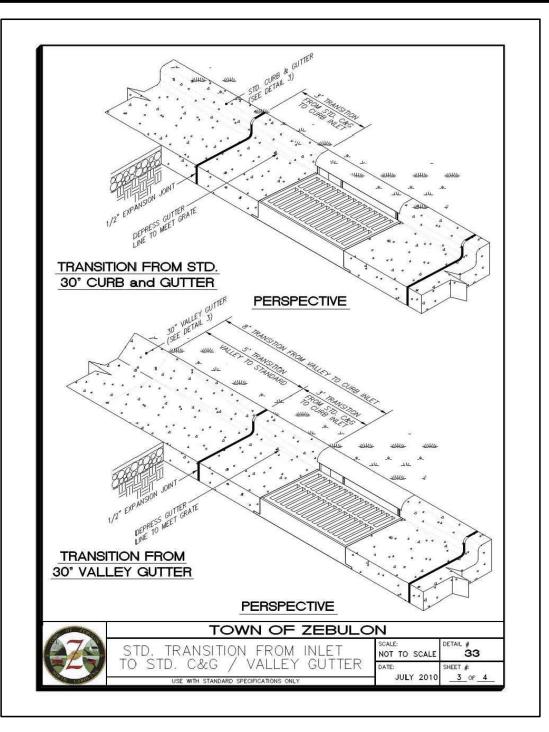
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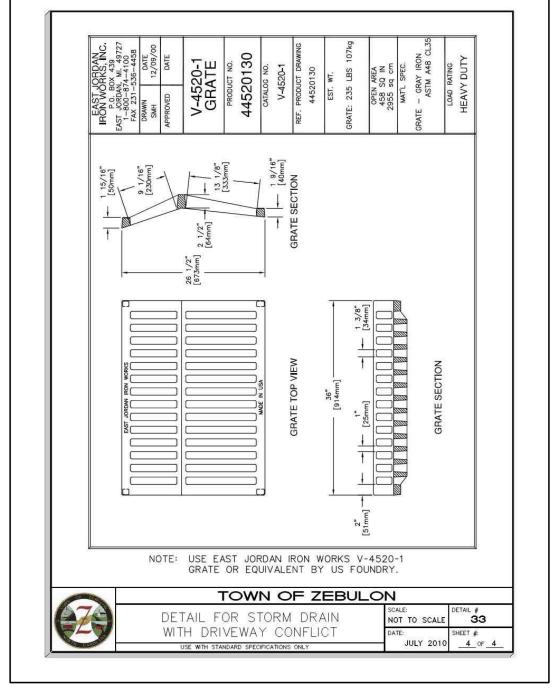
W-408<sup>-</sup>


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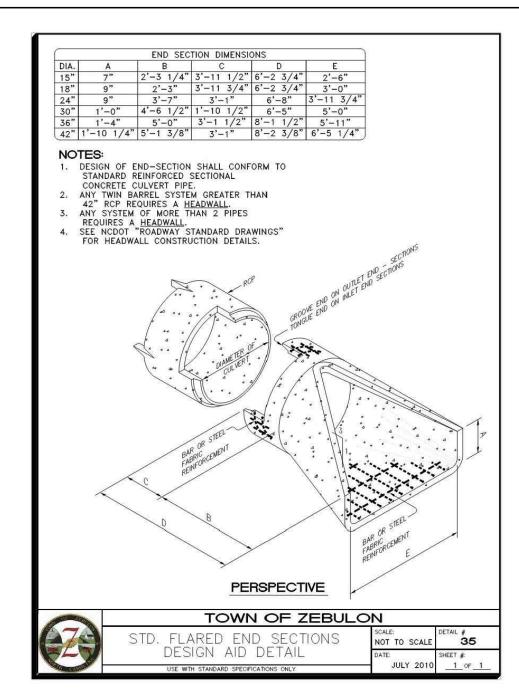











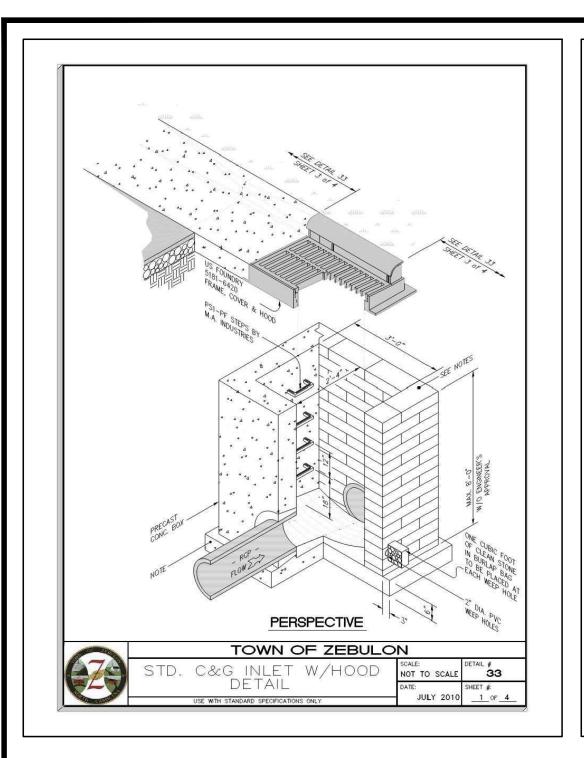

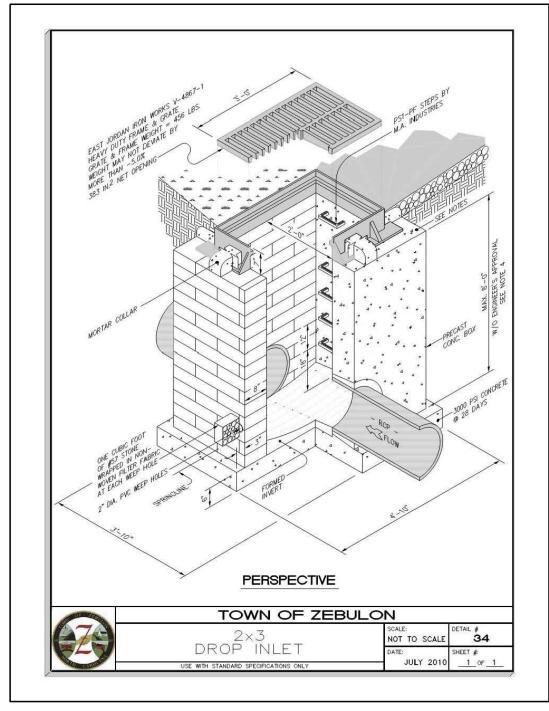


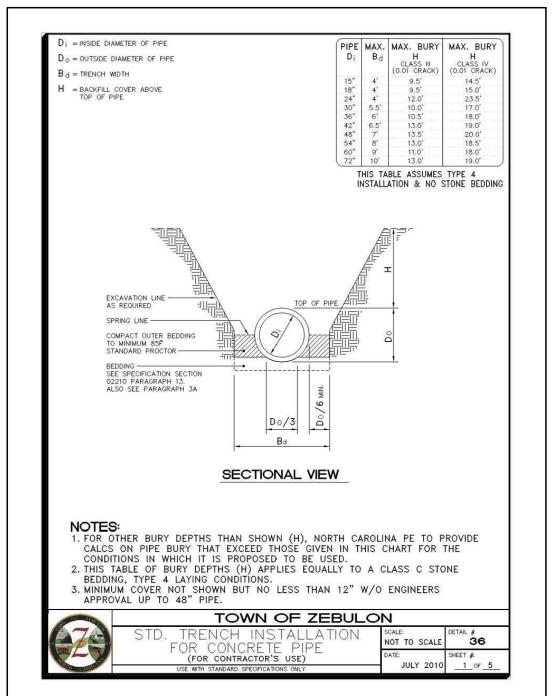


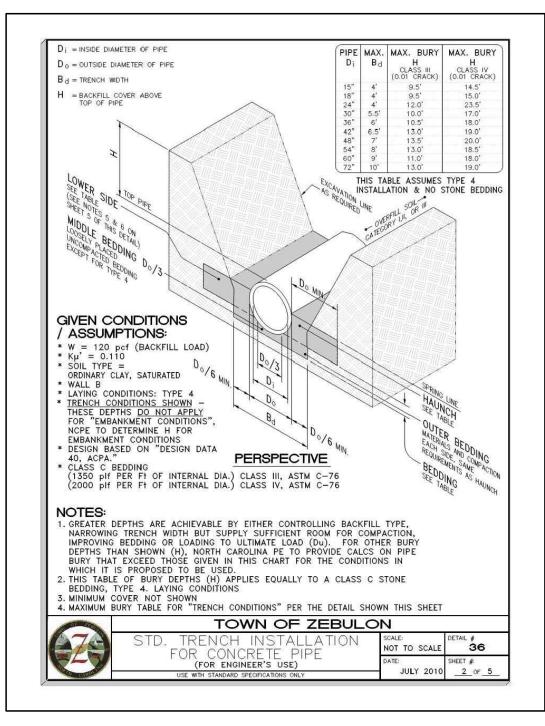


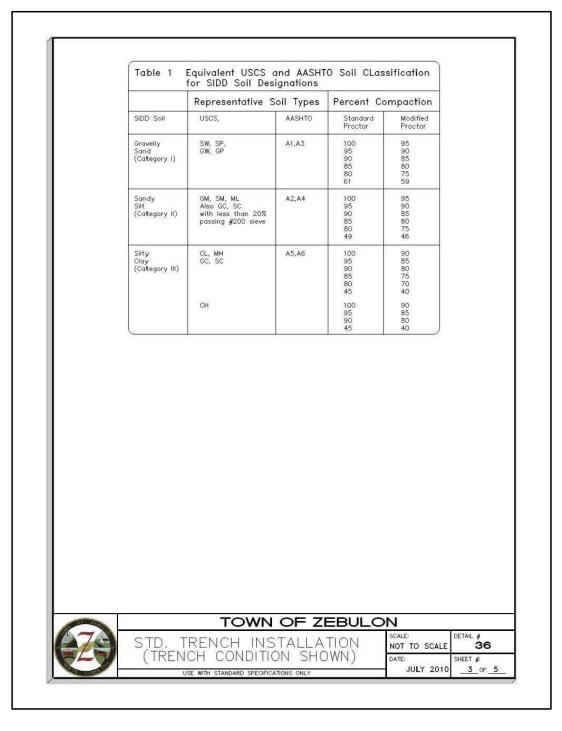


Installation Type * Bedding Thickness		Compaction Requiren		and Minimum			
Section   Sect	Installation Type 4	Bedding Thickness	Haunch and Outer Bedding	Lower Side			
less than 75 mm (3'). If rock foundation, use less than 150 mm (6').  Type 3  D <sub>0</sub> /24 minimum, not less than 150 mm (6'). If rock foundation, use less than 150 mm (6').  Type 4  D <sub>0</sub> /24 minimum, not less than 150 mm (6'). If rock foundation, use less than 150 mm (6').  Type 4  D <sub>0</sub> /24 minimum, not less than 150 mm (6'). If rock foundation, use less than 150 mm (6').  Type 4  D <sub>0</sub> /24 minimum, not less than 150 mm (6'). If rock foundation, use less than 150 mm (6').  Type 4  D <sub>0</sub> /24 minimum, not less than 150 mm (6').  No compaction required, except if Cotegory III. Coteg	Type 1	less than 75 mm (3"). If rock foundation,use Do /12 minimum, not	98% Category I	95% Category II, or			
Heis than 75 mm (3")   90% Category III   90% Category III   95% Cat	Type 2	les than 75 mm (3"). If rock foundation, use Do/12 minimum.not	or	90% Category II, or			
less than 75 mm (3'). If rock foundation, use Do/12 minimum, not less than 150 mm (6'').  Signaction and soils symbols — i.e. "98% Category I' refers to Category III. Use 85% C	Туре 3	less than 75 mm (3"). If rock foundation, use Do/12 minimum, not	90% Category II, or	90% Category II, or			
npaction and soils symbols — i.e. "98% Category I' refers to Category 1 soil aterial with a minimum standard Proctor compaction of 98%. See Table 1 for uivalent modified Proctor values.  In the outer bedding, haunch, and lower side zones, except within DO/3 from a pipe springline, shall be compacted to at least the same compaction as the ajority of the soil in the overfill zone.  Otherches subtrench is defined as a trench with its top below finished grade by more an 0.1 H or, for roadways, its top is at an elevation lower than 0.3 m (1') low the bottom of the pavement base material. It is minimum width of a subtrench shall be 1.33 Do or wider if required for equate space to attain the specified compaction in the haunch and bedding nes.  Our subtrenches with wall of natural soil, any portion of the lower side zone in a subtrench wall shall be at least as firm as an equivalent soil placed to the mpaction requirements specified for the lower side zone and as firm as the ajority of soil in the overfill zone, or shall be removed and replaced with soil mpacted to the specified level.	Type 4	less than 75 mm (3"). If rock foundation, use Do /12 minimum, not	required, except if Category III, use 85%	required, except if Category III, use 85%			
e 4 installation = little or no control over material and compaction.	paction and erial with a livalent modifin the outer pipe springliority of the renches subtrench is no.1 Hor, by the bottom way and the space es.  subtrenches subtrenches subtrenches subtrenches subtrenches ority of soil apacted to the elimital with a linstallation results and the subtrenches s	minimum standard Proied Proctor values. bedding, haunch, and ne, shall be compacted soil in the overfill zone defined as a trench wifor roadways, its top is n of the pavement basyidth of a subtrench shall be at least as all shall be at least as irements specified for in the overfill zone, or ie specified level.	lower side zones, if to at least the solution to the state of the stat	98%. See Table except within DO/ ime compaction a nished grade by many mished grade by many mished grade by many mished grade by many mished bed and bed of the lower side zo and as firm as and replaced with gh compaction eff	1 for 3 from s the nore (1') for ing ne in the the soil		

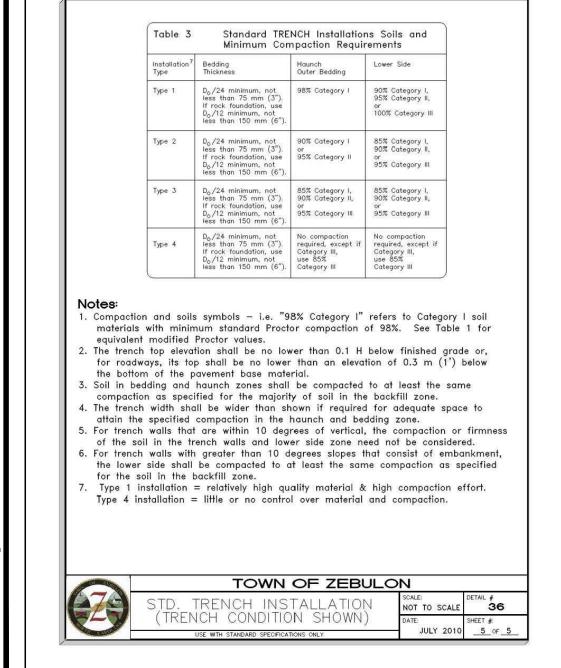

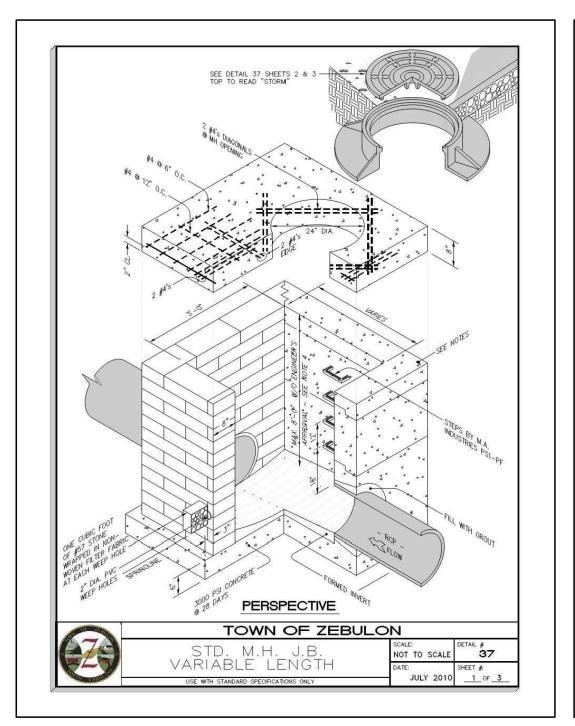


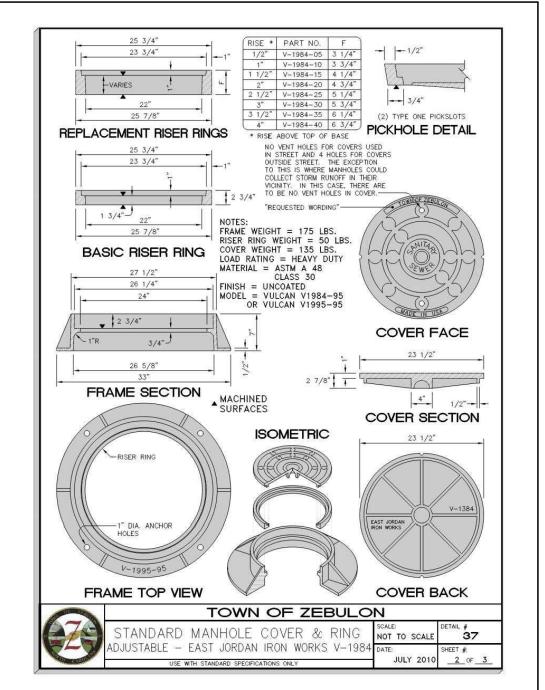

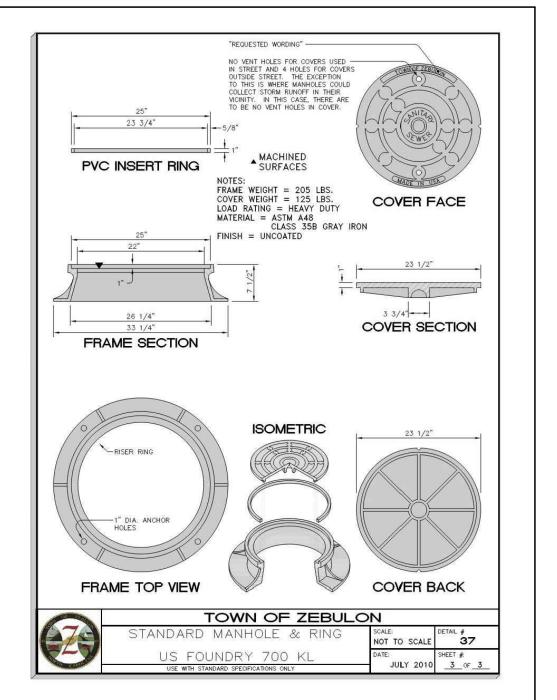


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ALL CONSTRUCTION TO BE IN ACCORDANCE WITH TOWN OF ZEBULON, NCDOT & NCDEQ STANDARDS, SPECIFICATIONS AND DETAILS.

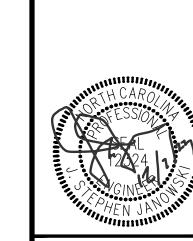

**REVISIONS:** 

JSJ W-408<sup>-</sup>

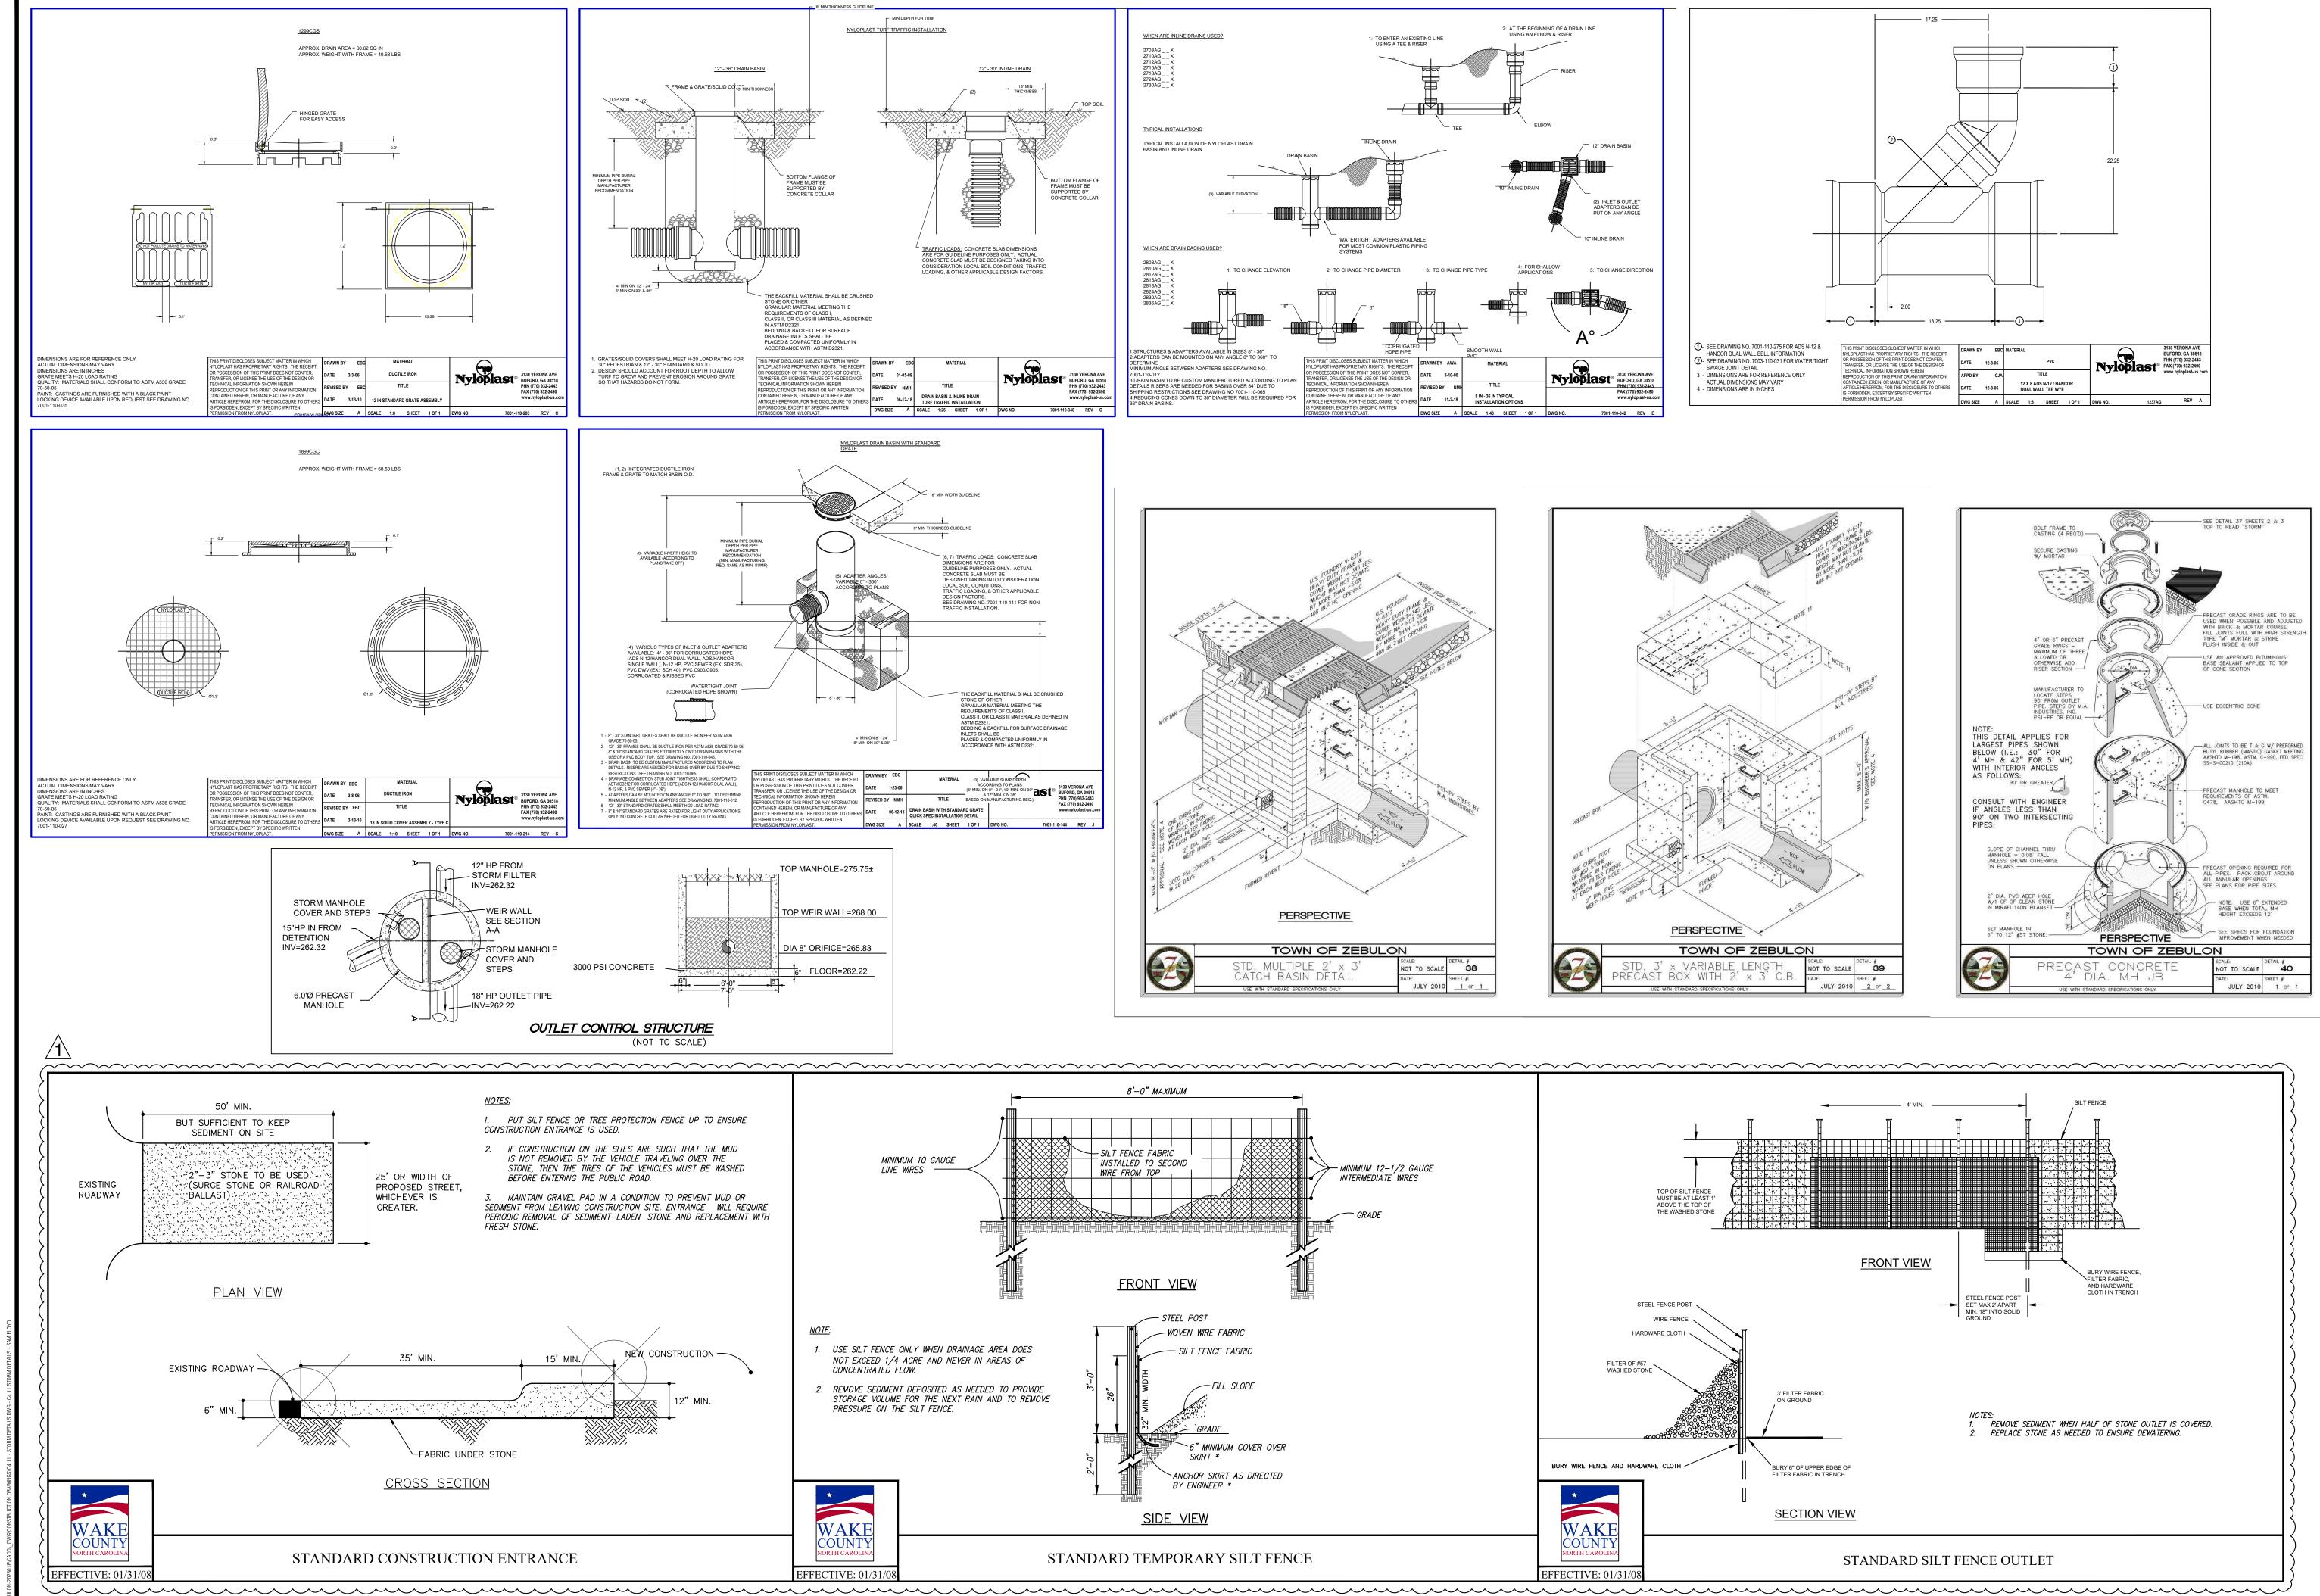

ALL CONSTRUCTION TO BE IN ACCORDANCE WITH TOWN OF ZEBULON, NCDOT & NCDEQ STANDARDS, SPECIFICATIONS AND DETAILS.






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	WINGS SUBMITTAL #2			VINGS SUBMITTAL #1	SCRIPTION

$\overline{m{\mathcal{V}}}$	$ 4\rangle$ construction drawings submittal #2	,
	CLIENT REVIEW	,
	TRC REVIEW PLAN	'
	CONSTRUCTION DRAWINGS SUBMITTAL #1	)
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AS SHOWN



LANDSCAPE CALCULATIONS

PARKING LOT:

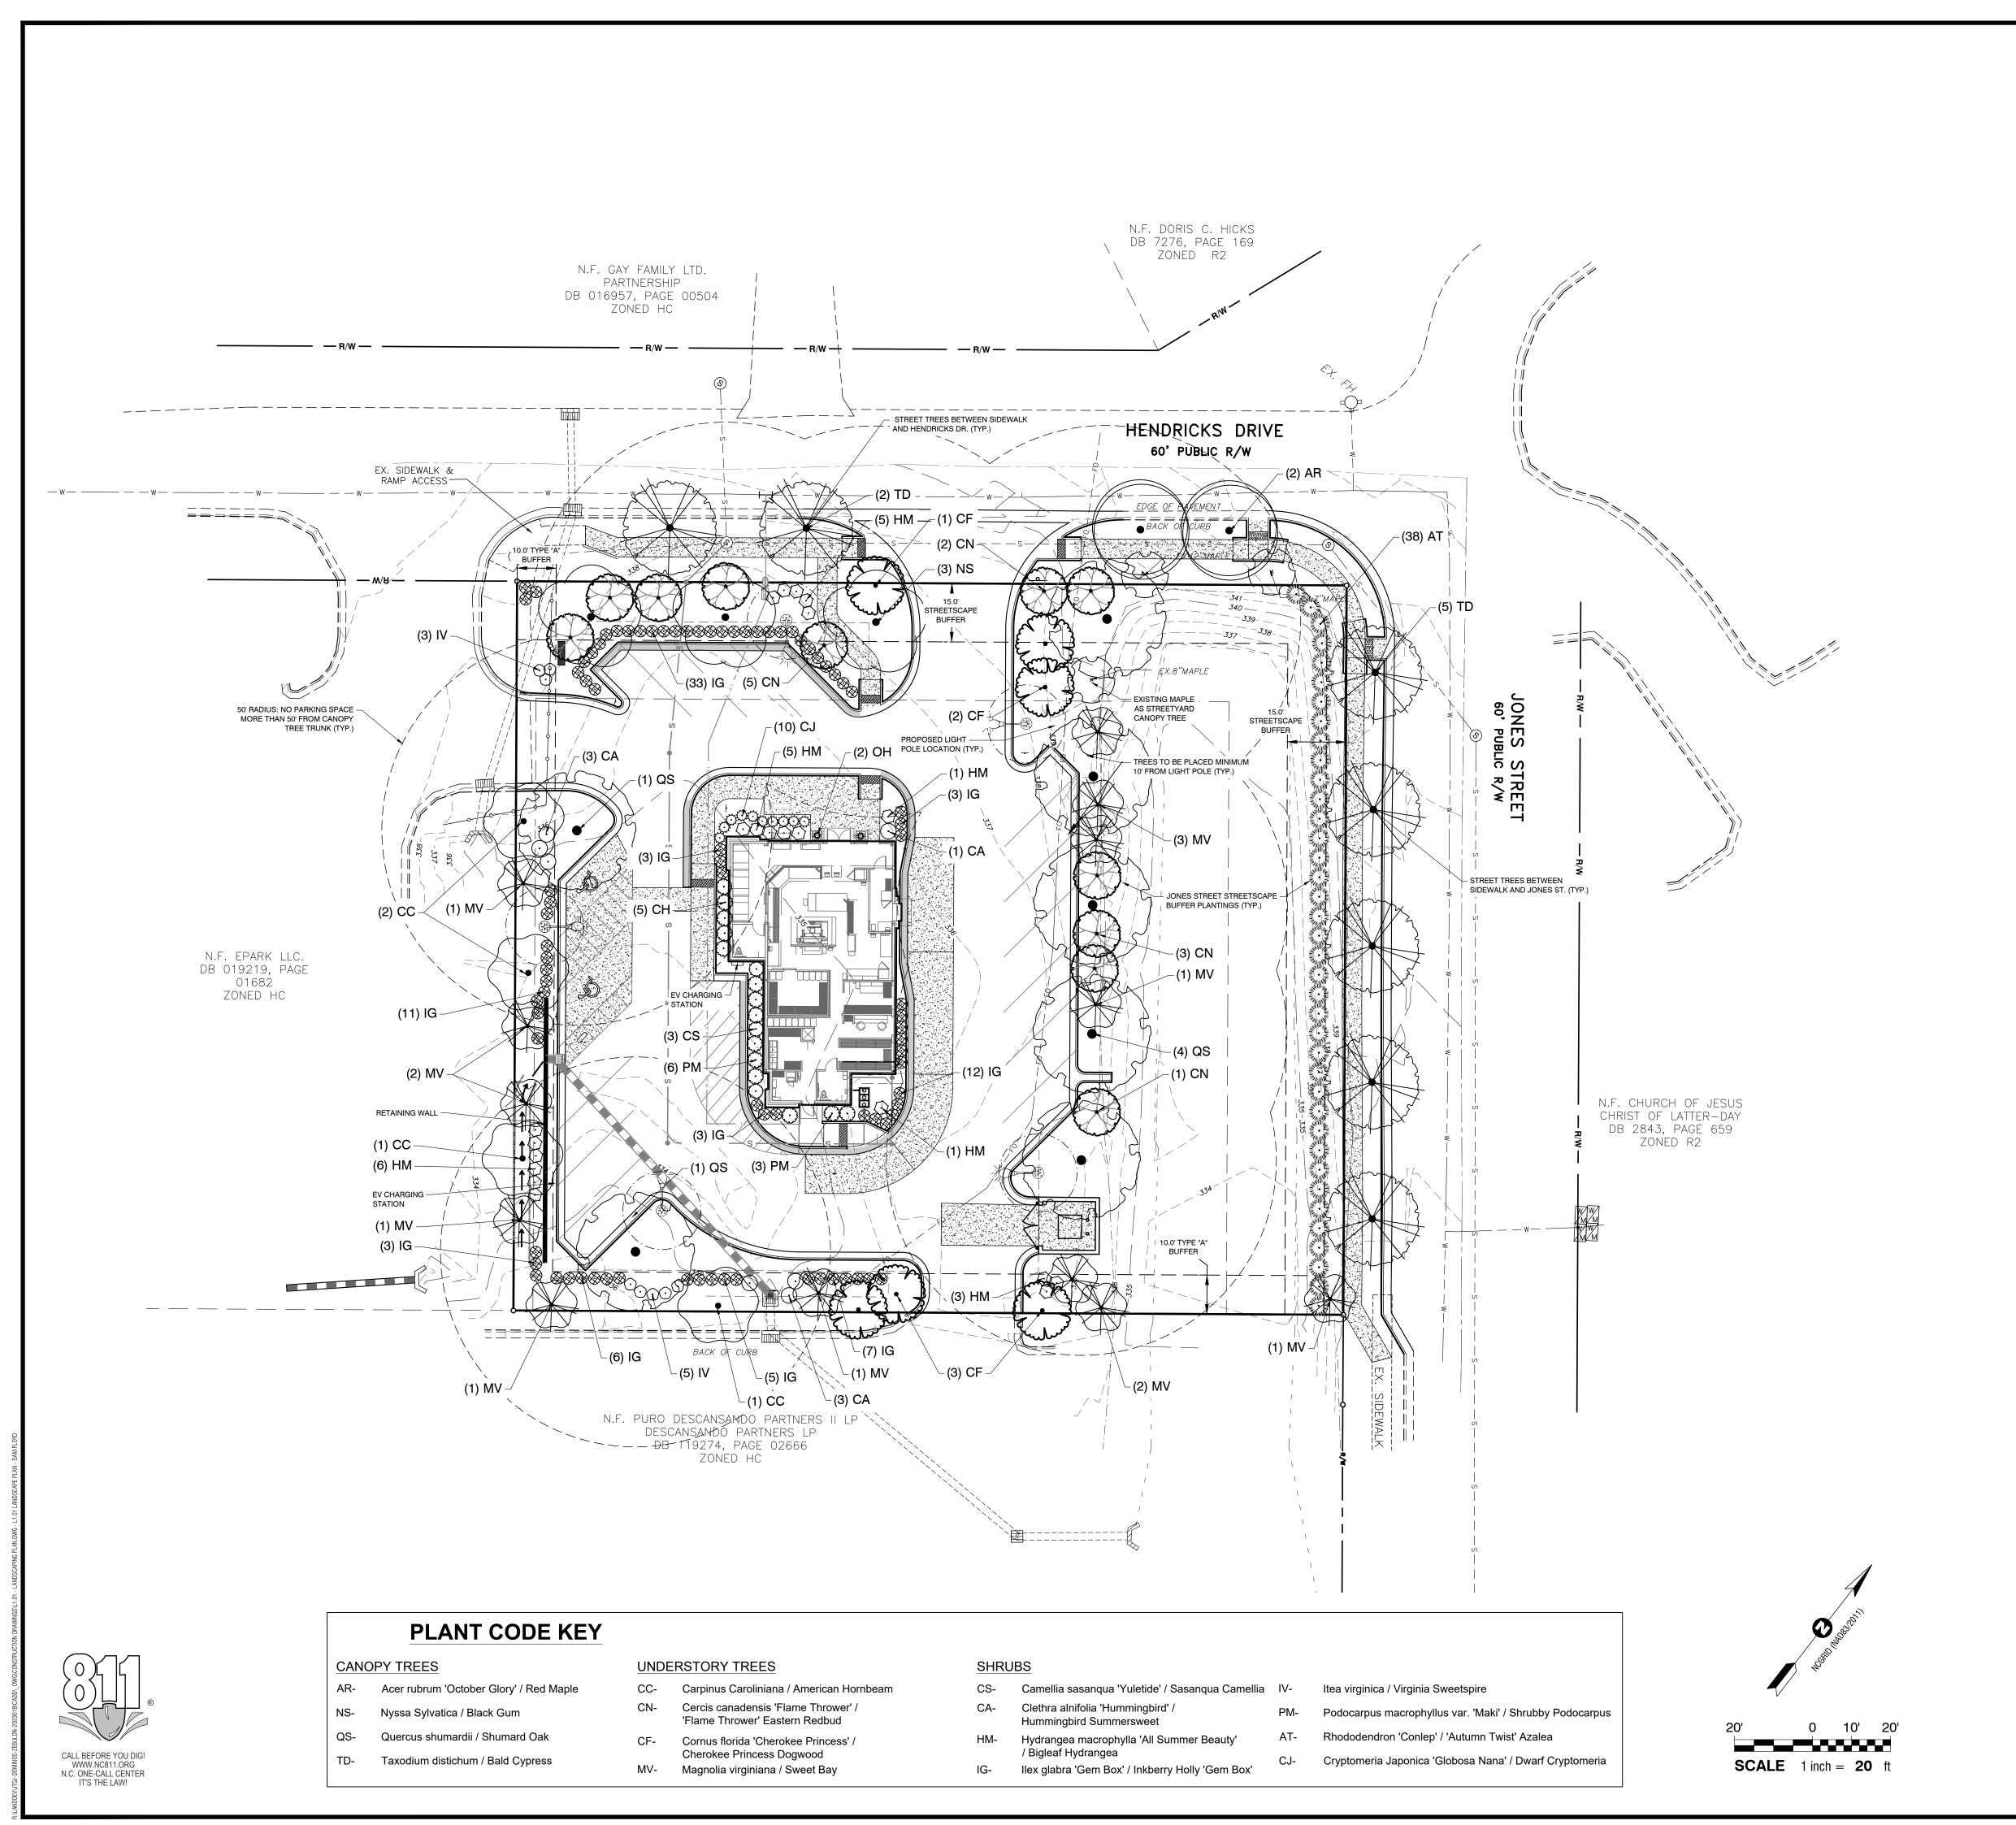SHADE TREES -REQUIRED - 1 CANOPY TREE / 12 OFF-STREET PARKING SPACES 17 PARKING SPACES = 2 CANOPY TREE REQUIRED PROPOSED - 2 CANOPY TREES, ALL PARKING SPACES WITHIN 50' OF A CANOPY TREE TRUNK LOCATION

INTERIOR PLANTINGS -REQUIRED - 3 SHRUBS / PARKING LOT ISLAND WHERE CANOPY TREE IS NOT PROVIDED.

PROPOSED - N/A

PERIMETER PLANTINGS -REQUIRED - SINGLE CONTINUOUS ROW OF EVERGREEN SHRUBS (MAX. 3' O.C.) ADJACENT TO PARKING LOT PERIMETER, WITHIN 5' OF PARKING LOT EDGE. PERIMETER PLANTINGS NOT REQUIRED ALONG COMMON BOUNDARY BETWEEN PARKING

PROPOSED - EVERGREEN SHRUB ROW PROVIDED AT PARKING ALONG HENDRICKS DR WITH STREETSCAPE BUFFER. SCREENING PROVIDED BY STREETSCAPE BUFFER FOR JONES

PERIMETER BUFFERS: REQUIRED - PERIMETER BUFFER PLANTINGS ALONG ADJACENT LOTS. SITE ZONING = HC

REAR LOT - ZONE HC = TYPE 'A' BUFFER "SEPARATION" (188 LF WITHOUT DRIVEWAY WIDTH) NO CANOPY TREES REQUIRED 1 UNDERSTORY TREE / 100 LF, 188 LF = 8 TREES REQUIRED 15 SHRUBS / 100 LF, 188 LF = 29 SHRUBS REQUIRED SIDE LOT - ZONE HC = TYPE 'A' BUFFER "SEPARATION" (162 LF WITHOUT DRIVEWAY WIDTH) NO CANOPY TREES REQUIRED 1 UNDERSTORY TREE / 100 LF, 162 LF = 7 TREES REQUIRED 15 SHRUBS / 100 LF, 187 LF = 25 SHRUBS REQUIRED

PROPOSED - REAR LOT - TYPE 'A' BUFFER 8 UNDERSTORY TREES PROVIDED, 29 SHRUBS PROVIDED SIDE LOT - TYPE 'A' BUFFER

7 UNDERSTORY TREES PROVIDED, 25 SHRUBS PROVIDED. FOUNDATION: REQUIRED - EVERGREEN SHRUBS OR DECORATIVE GRASSES

> (MIN. 18") LOCATED WITHIN 10' OF BUILDING FOUNDATION WALL VISIBLE FROM PUBLIC STREET. 1 CANOPY TREE / 2,000 SF OF LOT AREA FOR FIRST 20,000 SF OF LOT. 0.91 AC =  $\pm$  4.39640 SF, 10 TREES REQUIRED.

PROPOSED - EVERGREEN SHRUBS PROVIDED AT FOUNDATION OF PROPOSED BUILDING WHERE PLANTING IS VIABLE 11 CANOPY TREES PROVIDED (10 NEW, 1 EXISTING)

STREETSCAPE BUFFERS:

REQUIRED - 15' STREETSCAPE BUFFER AT HENDRICKS & JONES ST 3 CANOPY TREES @ 33' O.C / 100' REQUIRED 6 UNDERSTORY TREES @ 16' O.C / 100' REQUIRED 20 CANOPY TREES @ 5' O.C / 100' REQUIRED HENDRICKS DR: 213 LF - 37' DRIVEWAY - 52' POND BANK =124 LF

3 X 1.24 = 4 CANOPY TREES REQUIRED 4 NEW CANOPY TREES PROVIDED 6 X 1.24 = 8 UNDERSTORY TREES REQUIRED 8 NEW UNDERSTORY TREES PROVIDED

20 X 1.24 = 25 SHRUBS REQUIRED 25 NEW SHRUBS PROVIDED JONES ST: 187 LF

5 NEW, 1 EXISTING CANOPY TREES PROVIDED 6 X 1.87 = 11 UNDERSTORY TREES REQUIRED 11 NEW UNDERSTORY TREES PROVIDED

3 X 1.87 = 6 CANOPY TREES REQUIRED

20 X 1.87 = 38 SHRUBS REQUIRED 38 NEW SHRUBS PROVIDED

REQUIRED - ALL TOWN-MAINTAINED STREETS SHALL INCLUDE STREET TREES ALONG BOTH SIDES OF THE STREET WITHIN TREE PITS OR MIN. 5' PLANTING STRIPS. CANOPY TREES SHALL BE PLANTED 45-50' ON CENTER.

HENDRICKS DRIVE: 2 NEW CANOPY TREES, 2 EXISTING CANOPY JONES STREET: 5 NEW CANOPY TREES IN NEW PLANTING STRIP.

**REVISIONS:** 

	DESIGNED BY:	SBF
	DRAWN BY:	SBF
	CHECKED BY:	PRM
	PROJECT No.	2023018
	DRAWING No.	W-4081
	SCALE:	AS SHOWN
	SHEET No.	
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TOWN OF ZEBULON, NCDOT & NCDEQ STANDARDS, SPECIFICATIONS AND DETAILS.

NOTES:


1. ALL UNPAVED AREAS OF THE SITE WILL BE COVERED WITH HYBRID TURF TYPE TALL FESCUE SOD OR AGED TRIPLE SHREDDED HARDWOOD MULCH (3" MAX. DEPTH) IN A TYPICAL FASHION FOR THIS TYPE OF PROJECT.

ALL CONSTRUCTION TO BE IN ACCORDANCE WITH


		QS	Quercus shumardii / Shumard Oak	B & B	3" CAL.	14` - 16` HT.	7
		TD	Taxodium distichum / Bald Cypress	B & B	3" CAL.	14` - 16` HT.	7
ι	JNDERSTOR'	Y TREES					

7/						
UNDERSTOR	Y TREES					
	СС	Carpinus Caroliniana / American Hornbeam	B & B	2" CAL.	12` - 14` HT.	4
	CN	Cercis canadensis 'Flame Thrower' / 'Flame Thrower' Eastern Redbud	B & B	2" CAL.	12` - 14` HT.	11
	CF	Cornus florida 'Cherokee Princess' / Cherokee Princess Dogwood	B & B	2" CAL.	12` - 14` HT.	6
	MV	Magnolia virginiana / Sweet Bay	B & B	2" CAL.	12` - 14` HT.	13
SYMBOL	CODE	BOTANICAL / COMMON NAME	CONTAINER	SPACING	SIZE	QTY


SYMBOL	CODE	BOTANICAL / COMMON NAME	CONTAINER	SPACING	SIZE	QTY
SHRUBS						
	cs	Camellia sasanqua 'Yuletide' / Sasanqua Camellia	7 gal	SEE PLAN	36" MIN HT	3
•	CA	Clethra alnifolia 'Hummingbird' / Hummingbird Summersweet	3 gal	SEE PLAN	36" MIN HT	7
•	НМ	Hydrangea macrophylla 'All Summer Beauty' / Bigleaf Hydrangea	3 gal	SEE PLAN	36" MIN HT	21
•	IG	llex glabra 'Gem Box' / Inkberry Holly 'Gem Box'	3 gal	3` O.C.	36" MIN HT	86
•	IV	Itea virginica / Virginia Sweetspire	3 gal	3` O.C.	36" MIN HT	8
	1	1			1	

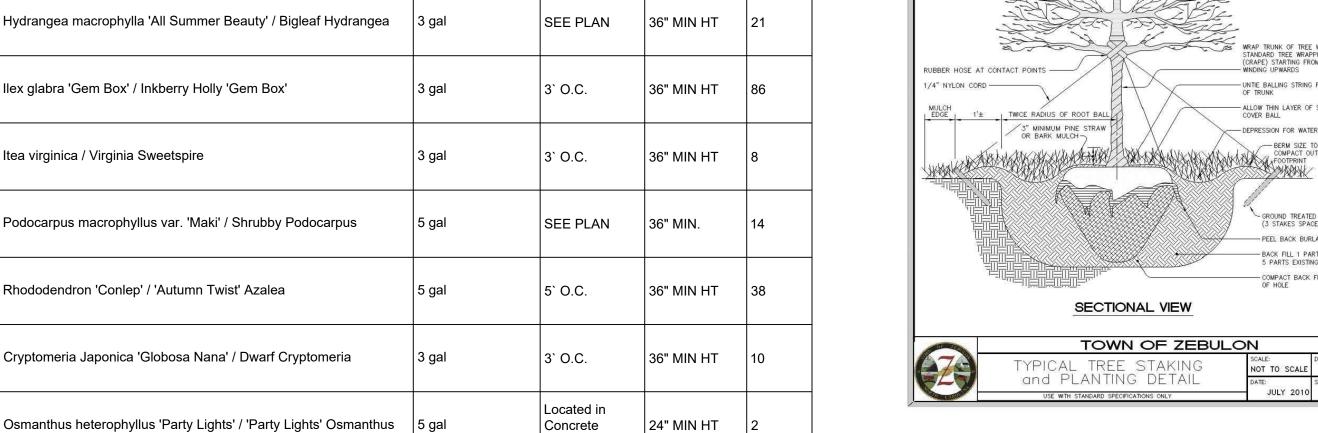

## OSMANTHUS HETEROPHYLLUS 'PARTY LIGHTS' 25" L - 2-3" TRIPLE-SHREDDED HARDWOOD MULCH 30" L - POTTING SOIL MIX 30" H - NON-WOVEN GEOTEXTILE FILTER FABRIC - 8"-10" WASHED PEA GRAVEL 1" THICK CONCRETE SPACER. 30" L CONTRACTOR TO ENSURE STABLE PLACEMENT OF PLANTER. - 4" X 4" X 1" THICK CONCRETE SPACER. - DRAINAGE HOLE CONTRACTOR TO ENSURE STABLE PLACEMENT OF PLANTER.

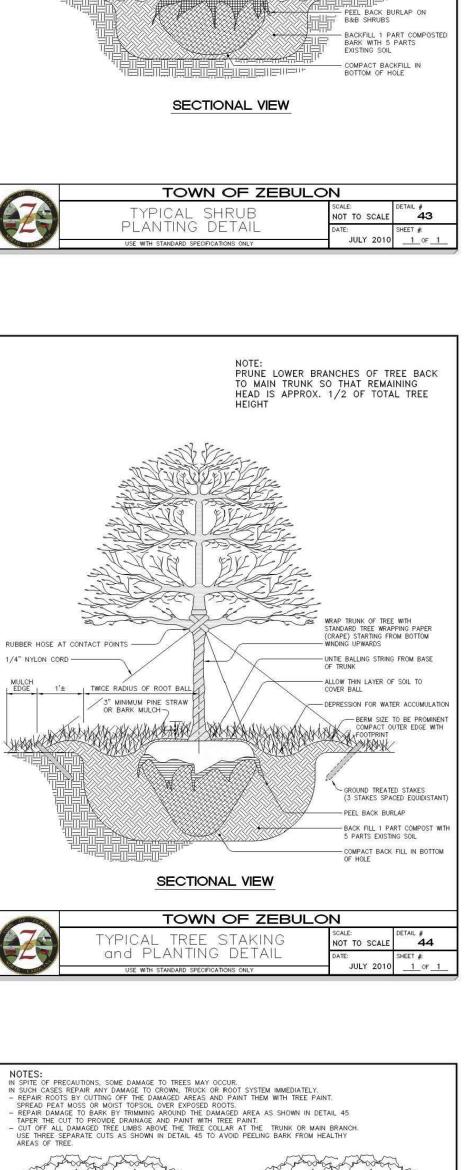

- IMPORTED TOP SOIL

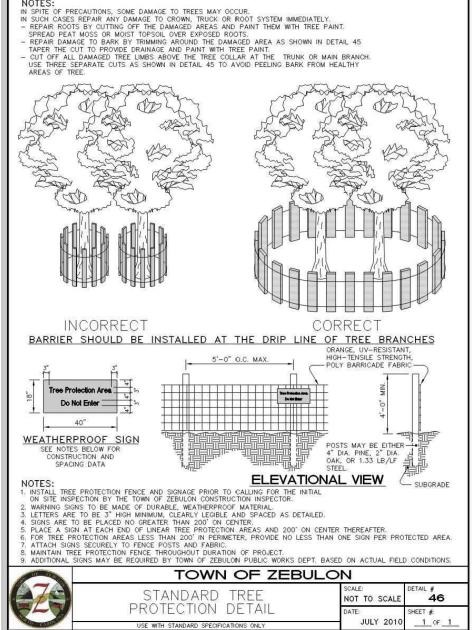


### **PLANTING NOTES:**

- 1. ALL PLANTINGS SHALL COMPLY WITH CURRENT LOCAL ORDINANCES AND GUIDELINES.
- 2. THIS PLAN IS FOR PLANTING LOCATIONS ONLY AND ALL PLANT MATERIAL SHALL BE SPACED AND LOCATED PER SCHEDULE. HOWEVER, CONTRACTOR TO SLIGHTLY ADJUST PLANT LOCATIONS IN THE FIELD AS NECESSARY TO BE CLEAR OF DRAINAGE SWALES AND UTILITIES. IF FOUND CONDITIONS VARY FROM THIS PLAN, CONTRACTOR SHALL CONTACT OWNER AND LANDSCAPE ARCHITECT FOR RESOLUTION. FAILURE TO DO SO WILL RESULT IN CONTRACTOR'S LIABILITY TO REPLACE PLANT
- 3. REFER TO PLANTING DETAILS FOR ADDITIONAL PLANTING INFORMATION.
- 4. CONTRACTOR SHALL BE SOLELY RESPONSIBLE FOR ALL PLANT WATERING AND MAINTENANCE, INCLUDING SHRUBS AND GROUNDCOVER, AND SHALL MAINTAIN AREA IN A WEED AND DEBRIS FREE CONDITION, THROUGHOUT GUARANTEE PERIOD.
- 5. CONTRACTOR TO VERIFY PLANT LIST TOTALS WITH QUANTITIES SHOWN ON PLAN.
- 6. ALL SIZES SPECIFIED IN THE PLANT LIST ARE MINIMUM SIZES TO WHICH THE PLANTS ARE TO BE JUDGED. FAILURE TO MEET MINIMUM SIZE ON ANY PLANT WILL RESULT IN REJECTION OF THAT
- 7. PLANTING SIZE DETERMINATION: 7.1. TREES: HEIGHT SHALL BE MEASURED FROM THE CROWN OF THE ROOT BALL TO THE TOP OF MATURE GROWTH. SPREAD SHALL BE MEASURED TO THE END OF BRANCHING EQUALLY AROUND THE CROWN FROM THE CENTER OF THE TRUNK. MEASUREMENTS ARE NOT TO INCLUDE ANY TERMINAL GROWTH. SINGLE TRUNK TREES SHALL BE FREE OF "V" CROTCHES THAT COULD BE POINTS OF WEAK LIMB STRUCTURE OR DISEASE INFESTATION.
- 7.2. ALL PLANTS SHALL BE FRESHLY DUG OR IN GROW POTS, SOUND, HEALTHY, VIGOROUS, WELL BRANCHED, FREE OF DISEASE, INSECT EGGS, AND LARVAE, AND SHALL BE WELL ROOTED.
- 8. FINISHED PLANTING BEDS SHALL BE GRADED SO AS TO NOT IMPEDE DRAINAGE AWAY FROM BUILDINGS. IF SIGNIFICANT RELOCATIONS ARE REQUIRED, CONTRACTOR SHALL CONTACT LANDSCAPE ARCHITECT FOR RESOLUTION. FAILURE TO MAKE SUCH RELOCATIONS KNOWN TO THE OWNER AND LANDSCAPE ARCHITECT WILL RESULT IN CONTRACTOR'S LIABILITY FOR PLANT MATERIALS AND STORMWATER DAMAGE.
- 9. FIELD LOCATE AND VERIFY UNDERGROUND UTILITIES LOCATIONS PRIOR TO PLANTING, FINAL TREE LOCATIONS TO BE FIELD ADJUSTED TO AVOID CONFLICTS WITH UTILITIES. LIGHTING AND DRIVEWAY LOCATIONS WHERE POSSIBLE. CONTACT LANDSCAPE ARCHITECT FOR A COORDINATED SOLUTION FOR ANY UTILITY CONFLICTS. CONTRACTOR SHALL BE LIABLE FOR DAMAGE TO ANY AND ALL PUBLIC OR PRIVATE UTILITIES.
- 10. TREES SHALL BE STAKED WITH AN AT GRADE TREE STAKING SYSTEM. STAKING MUST BE REMOVED AS SOON AS POSSIBLE OR WITHIN ONE (1) YEAR OF PLANTING. MULCH SHALL BE APPLIED IN AN EVEN THREE INCH (3") TO TO FOUR INCH (4") LAYER AROUND THE TREE PIT IN ACCORDANCE WITH ACCEPTED PRACTICES IN THE LANDSCAPE INDUSTRY.
- 11. CONTRACTOR SHALL NOT PLACE MULCH IN CONTACT WITH THE TRUNKS OF TREES OR SHRUBS.
- 12. ALL TREE PITS, SHRUB BEDS AND PREPARED PLANTING BEDS ARE TO BE COMPLETELY EXCAVATED IN ACCORDANCE WITH THE PLANTING DETAILS.
- 13. THE ROOT CROWN SHALL BE TWO INCHES (2") TO FOUR INCHES (4") ABOVE FINISHED GRADE (AFTER SETTLING) FOR SHRUBS AND ONE QUARTER  $\binom{1}{4}$  TO ONE HALF  $\binom{1}{3}$  THE BALL DEPTH ABOVE FINISH GRADE (AFTER SETTLING) FOR TREES.
- 14. ALL SUBSTITUTIONS OF PLANT MATERIAL ARE TO BE REQUESTED IN WRITING TO THE LANDSCAPE ARCHITECT AND APPROVED IN WRITING BY THE OWNER PRIOR TO INSTALLATION. FAILURE TO OBTAIN SUBSTITUTION APPROVAL IN WRITING MAY RESULT IN LIABILITY TO THE CONTRACTOR.
- 15. DEAD PLANTS ARE TO BE REMOVED FROM THE JOB BY THE CONTRACTOR WEEKLY. CONTRACTOR SHALL MAINTAIN AN UPDATED, COMPREHENSIVE LIST OF ALL DEAD MATERIALS REMOVED AND PRESENT A COPY OF THE LIST TO THE OWNER AND THE LANDSCAPE ARCHITECT AT THE END OF EVERY MONTH DURING THE CONTRACT PERIOD.
- 16. TOPSOIL REQUIRED FOR SOIL MIXES AND SPECIAL SEEDING AREAS SHALL BE PROVIDED BY THE CONTRACTOR. CONTRACTOR MUST LOAD, HAUL, MIX, AND SPREAD ALL TOPSOIL AND OTHER SOIL ADDITIVES AS REQUIRED.
- 17. THE PROPERTY OWNER AND/OR LESSEE SHALL, UPON COMPLETION OF THE GUARANTEE PERIOD AND FINAL ACCEPTANCE OF THE LANDSCAPE MATERIALS, MAINTAIN ALL LANDSCAPE MATERIALS AND LANDSCAPE AREAS IN ACCORDANCE WITH THE APPROVED LANDSCAPE PLAN. MAINTENANCE SHALL INCLUDE WATERING, WEEDING, MOWING, FERTILIZING, TREATING PESTS, MULCHING, PRUNING, REMOVAL AND REPLACEMENT OF DEAD OR DISEASED TREES AND SHRUBS. MAINTENANCE SHALL BE PERFORMED ON A REGULAR BASIS IN ORDER TO MAINTAIN PLANT VIGOR AND STABILITY AND TO PRESENT A NEAT AND WELL-KEPT APPEARANCE AT ALL TIMES.
- 18. CONTRACTOR SHALL GUARANTEE ALL LANDSCAPE IMPROVEMENTS, INCLUDING SEEDING, AS REQUIRED BY THE SPECIFICATIONS. CONTRACTOR MUST CONTACT THE OWNER AND THE LANDSCAPE ARCHITECT AT LEAST 10 WORKING DAYS IN ADVANCE TO SCHEDULE ACCEPTANCE INSPECTION(S). CONTRACTOR MUST REPLACE ALL DEAD OR UNACCEPTABLE PLANTS DURING THE FOLLOWING RECOMMENDED PLANTING SEASON.
- 19. ALL TREES AND SHRUBS SHALL MEET THE NORMAL REQUIREMENTS FOR THE AMERICAN STANDARD FOR NURSERY STOCK, LATEST EDITION, PUBLISHED BY THE AMERICAN ASSOCIATION OF NURSERYMAN (AAN) OR AMERICANHORT, ANSI Z60.1.
- 20. MULCH SHALL BE FREE OF DEBRIS AND WOOD CHIPS. IT SHALL CONSIST OF AGED TRIPLE-SHREDDED HARDWOOD MULCH, FREE OF EXCESS TANNIC ACID OR OTHER MULCH AS SPECIFIED ON THE PLANS. SAMPLES OF MULCH SHALL BE PROVIDED FOR THE THE LANDSCAPE ARCHITECT'S APPROVAL PRIOR TO DELIVERING THE MULCH. THE OWNER RESERVES THE RIGHT TO REJECT ANY MULCH WHICH IS CONSIDERED TO BE UNSUITABLE. ALL MULCHES SHALL BE FREE OF ANY FOREIGN MATERIALS, PIECES LARGER THAN 6 INCHES, AND/OR GREEN WOOD.
- 21. ALL STRAPPING AND TOP 2/3 OF WIRE BASKET MUST BE CUT AWAY AND REMOVED FROM ROOT BALL PRIOR TO BACKFILLING PLANTING PIT. REMOVE TOP 1/3 OF THE BURLAP FROM THE ROOT BALL. REMOVE ALL SYNTHETIC MATERIALS: BURLAP, STRAPPING CORDAGE, ETC. PRIOR TO BACKFILLING ALL PLANT MATERIALS.
- 22. NO PLANTING IDENTIFIED AS REACHING A MATURE HEIGHT OF MORE THAN TWENTY FEET (20') SHALL BE PLACED WITHIN A TRANSMISSION POWER LINE RIGHT-OF-WAY OR WITHIN TEN FEET (10') OF AN OVERHEAD UTILITY LINE.
- 23. TREES WHICH OVERHANG THE PEDESTRIAN CIRCULATION ROUTES AT THE STREETS, SIDEWALKS OR WITHIN OPEN SPACE AREAS SHALL NOT EXTEND GREATER THAN FOUR INCHES INTO THE CIRCULATION ROUTE AT A HEIGHT LESS THAN 80 INCHES ABOVE THE ADJACENT GRADE. ALL TREES SHALL BE LIMBED TO PROVIDE 80 INCHES OF CLEARANCE AT WALKWAYS TO MEET A.D.A AND ANSI

- CONTRACTOR SHALL FIELD VERIFY LOCATION, SIZE, AND MATERIAL OF EXISTING SITE AND VICINITY FEATURES AND UTILITIES PRIOR TO BEGINNING DEMOLITION AND CONSTRUCTION ACTIVITIES. CONTRACTOR SHALL NOTIFY THE CIVIL ENGINEER AND LANDSCAPE ARCHITECT OF ANY DISCREPANCIES THAT ARE FOUND BETWEEN THE EXISTING FIELD CONDITIONS AND THE SITE PLANS OR CONSTRUCTION DRAWINGS, WHENEVER THEY ARE FOUND, DURING ALL PHASES OF SITE WORK.
- THE PRUNING OF SCREENING SHRUBS SHALL ALLOW FOR LATERAL GROWTH OF BRANCHES SO AS TO FORM A HEDGE.
- ALL LANDSCAPE ISLANDS, BEDS AND LAWNS SHALL BE GRADED FOR POSITIVE DRAINAGE WITH NO LOW SPOTS ALLOWING WATER TO BE TRAPPED.
- 4. CONTRACTOR SHALL PLANT TREES AND SHRUBS 5 FEET FROM BACK OF CURB WHEN
- PLANTED PERPENDICULAR FROM PARKING SPACES. WHEEL STOPS ARE REQUIRED IF LANDSCAPING CANNOT BE SET BACK 5 FEET.
- CONTRACTOR SHALL INSTALL ALL SHRUBS IN MULCHED BEDS. CONTRACTOR SHALL INSTALL ALL TREES IN MINIMUM 4-6' DIA. MULCHED BEDS.
- 8. WHERE TREES AND SHRUBS ARE LOCATED TOGETHER IN LANDSCAPE BUFFERS, THE CONTRACTOR SHALL MULCH THE FULL WIDTH AND LENGTH OF THE BUFFER.
- 9. ALL UN-MULCHED AREAS OF THE SITE SHALL BE SEEDED WITH LAWN GRASS. GRASS SEED SELECTION SHALL BE SUBMITTED TO AND APPROVED BY THE LANDSCAPE ARCHITECT, PRIOR TO PURCHASE AND INSTALLATION.



ALL CONSTRUCTION TO BE IN ACCORDANCE WITH TOWN OF ZEBULON, NCDOT & NCDEQ STANDARDS, SPECIFICATIONS AND DETAILS.

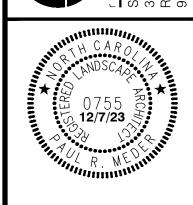

$\overline{\Psi}$	4 CONSTRUCTION DRAWINGS SUBMITTAL #2	12/07/23	
	CLIENT REVIEW	11/21/23	
	TRC REVIEW PLAN	11/07/23	
	CONSTRUCTION DRAWINGS SUBMITTAL #1	06/01/23	
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**REVISIONS:** 

DESIGNED BY:

SBF DRAWN BY: PRM, JSJ CHECKED BY: PROJECT No. 202301 W-408<sup>-</sup> RAWING No. AS SHOWN

<u>SPECIFICATIONS</u>

Weight: 155 lbs.

Made in the USA

weight and color

• Dimensions: 30"L x 30"D x 30"H

Suitable for Indoor/Outdoor Use

Weathers naturally outdoors

Makes a beautiful focal point for your garden setting, either filled with

Made of Glass Fiber Reinforced Concrete (GFRC) that mimics the look

• Due to the nature of materials used, natural variations can occur in size

Available in your choice of classic and distinct finishes

and feel of cast stone but is significantly lighter

Features unique designer detail and superior craftsmanship

Finish/Stain is hand applied by trained artisans

beautiful blooms or greens, or left empty as a wonderful accent piece


Shown in Alpine Stone (AS)

Metropolis Cube 3030 Planter

Concrete

**CONCRETE PLANTER** 

N.T.S.

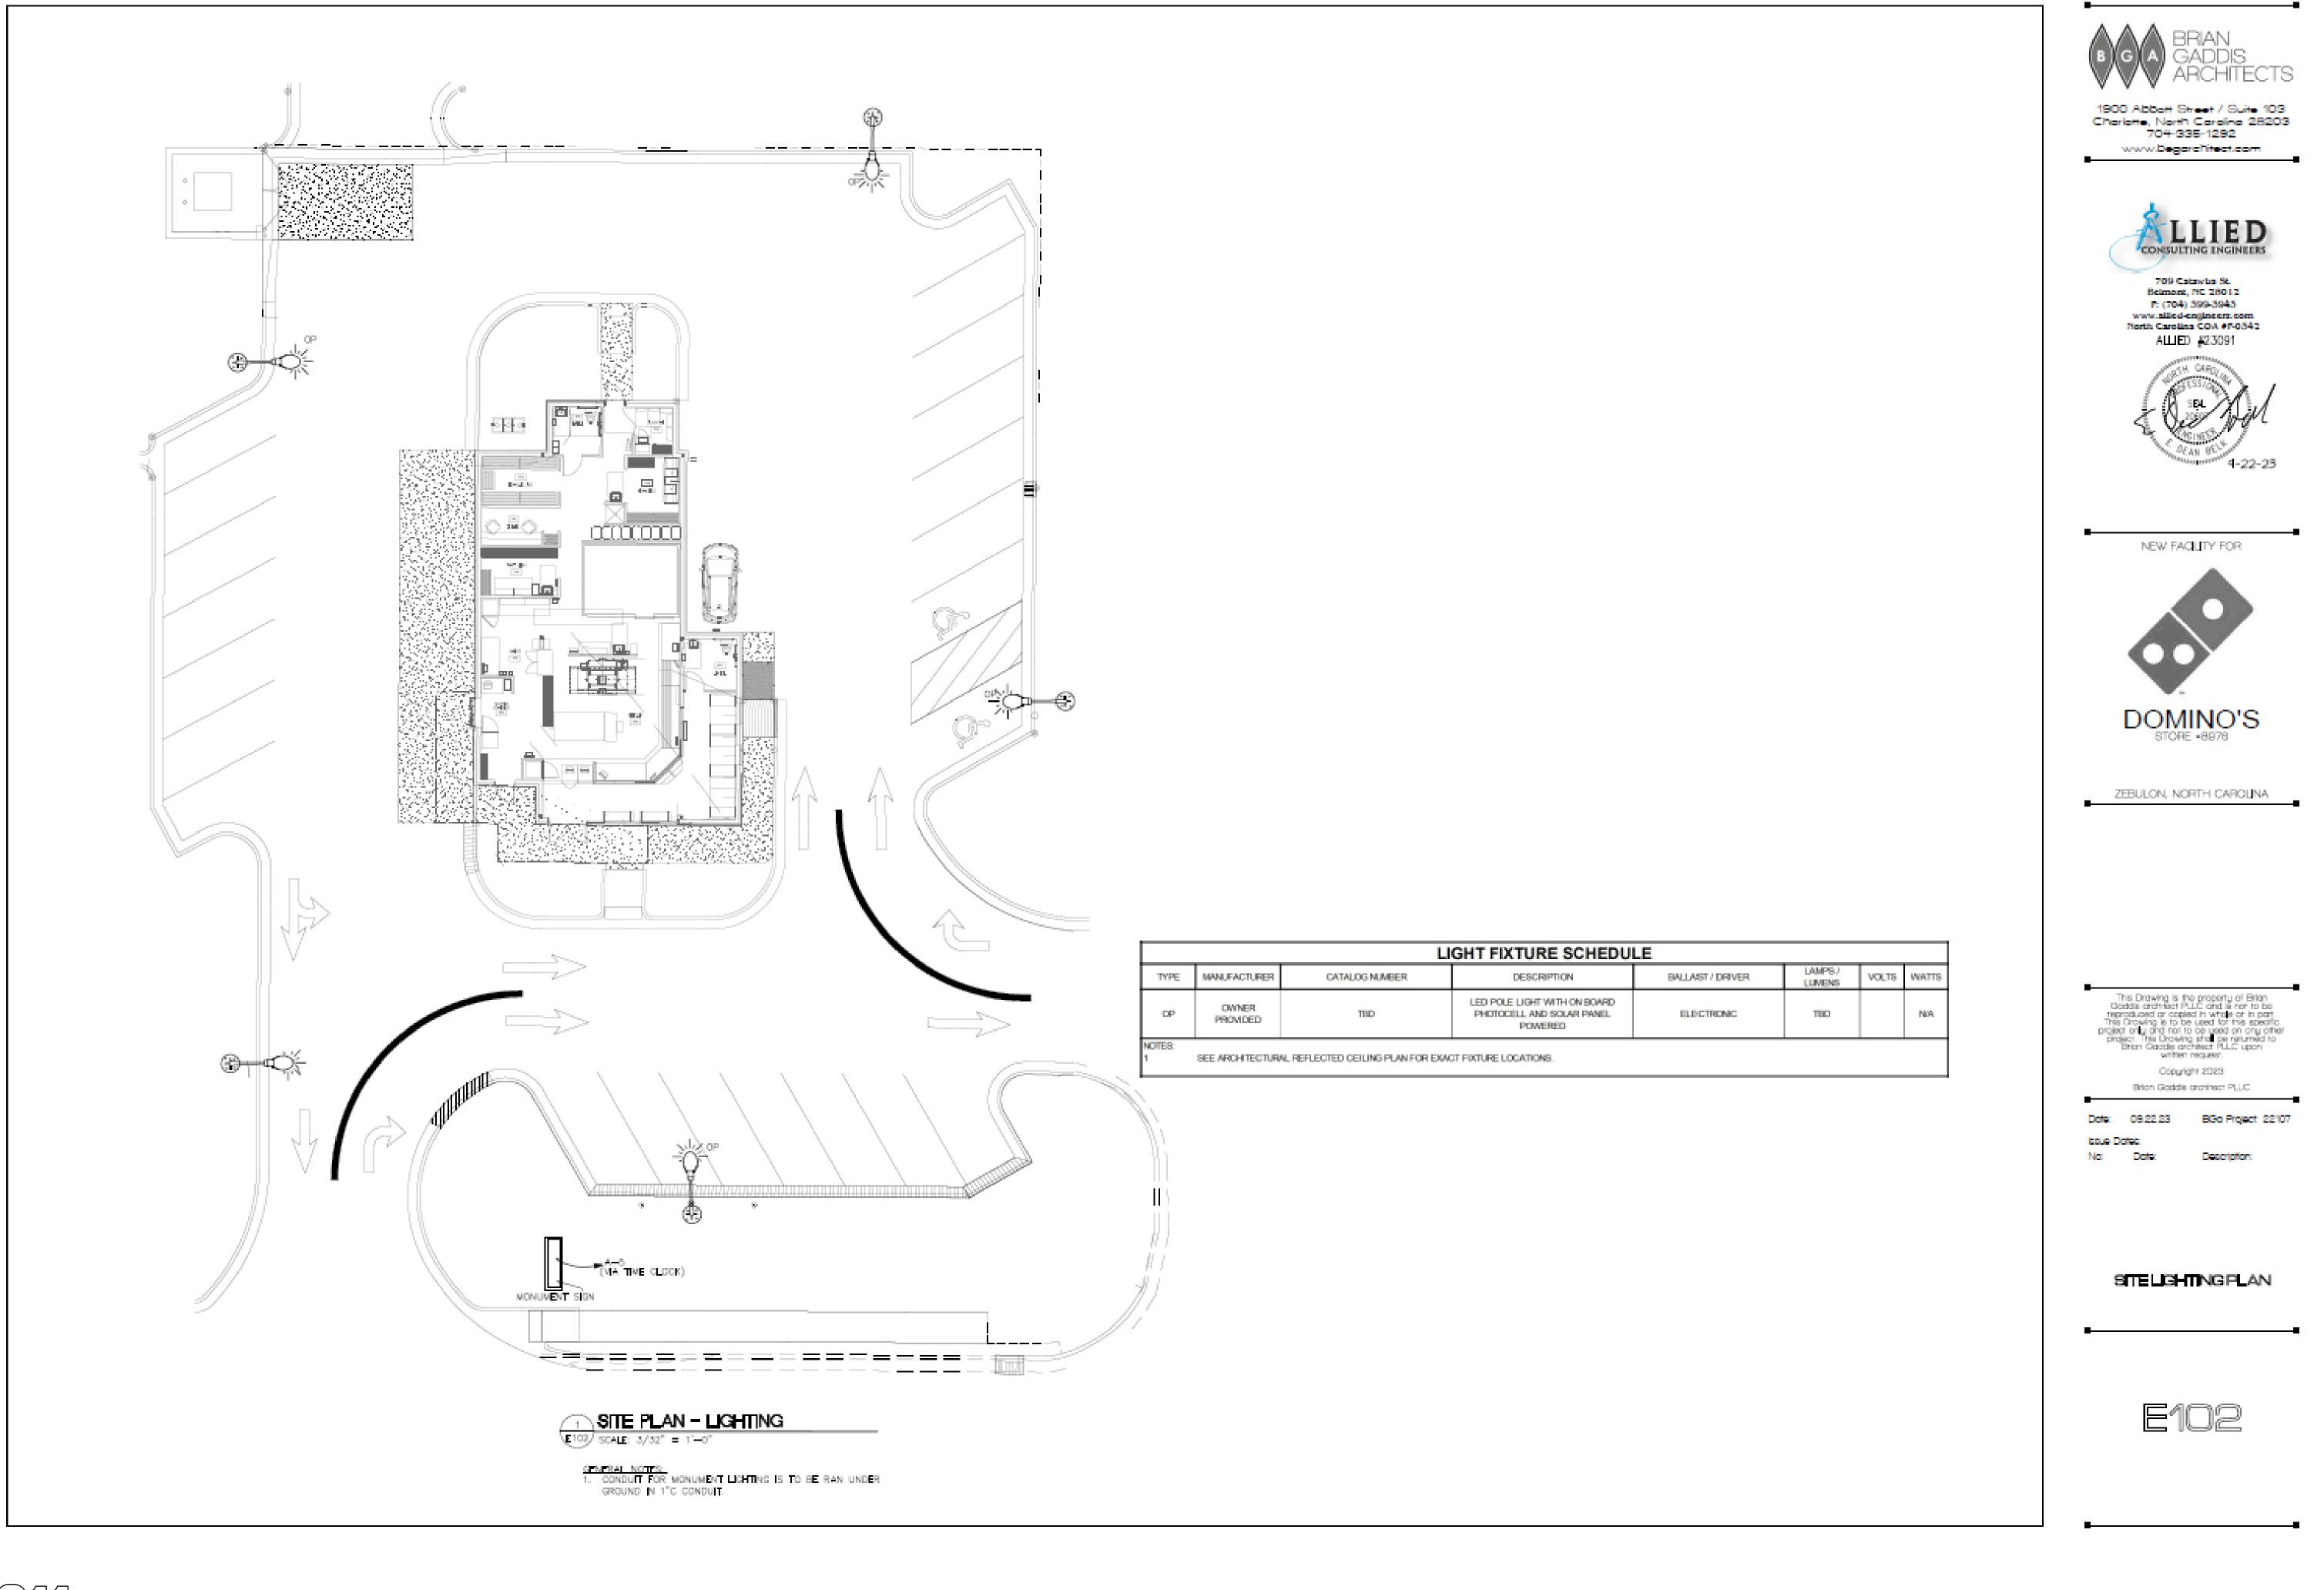






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NEW FACILITY FOR



ZEBULON, NORTH CAROLINA



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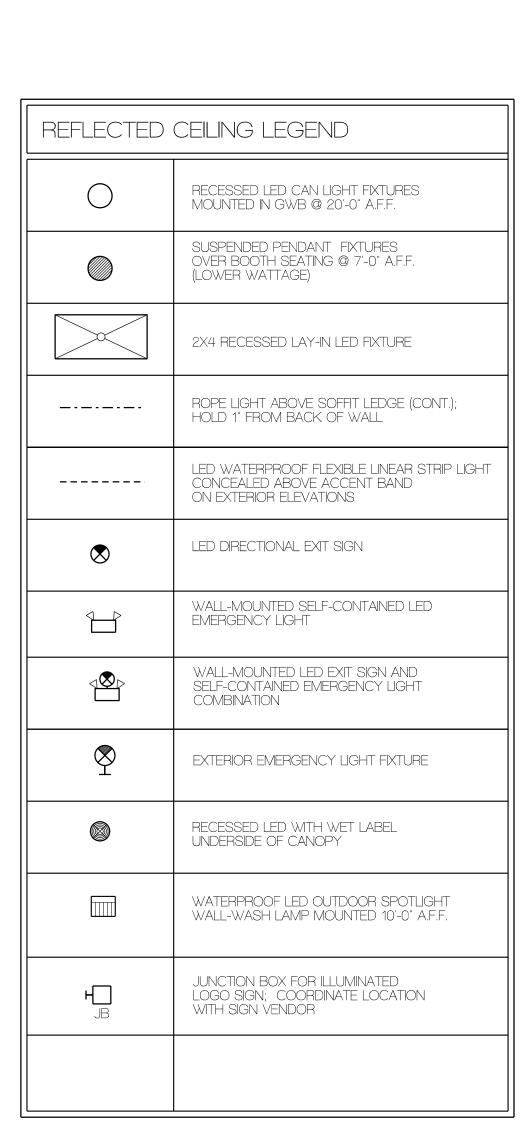
Date: Description:

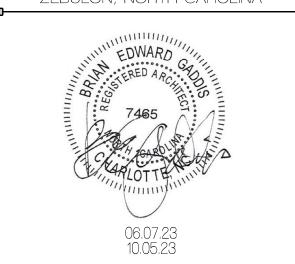10.05.23 TOWN OF ZEBULON ZONING REVISIONS

REFLECTED CEILING PLAN AND

LIGHTING SCHEDULE

A103





NOTE: SEE ELECTRICAL DRAWING FOR MORE INFORMATION ON FIXTURES.

NOTE: CEILING TILE IN KITCHEN AND BACK OF HOUSE TO BE 2' X 4' GRID. SEE FINISH SCHEDULE FOR "CT-01" SPECIFICATION OF CEILING TILE AND GRID.


NOTE: ALL EXTERIOR LIGHTS AND SIGNAGE TO BE ON A 1-HOUR TIMER.

NOTE: SEE INTERIOR ELEVATION 01/A500 AND MECHANICAL DRAWINGS FOR LOCATION AND SIZE OF LINEAR MECHANICAL DIFFUSERS IN CUSTOMER AREA. LOCATED ON FACE OF UPPER SOFFIT WALL.

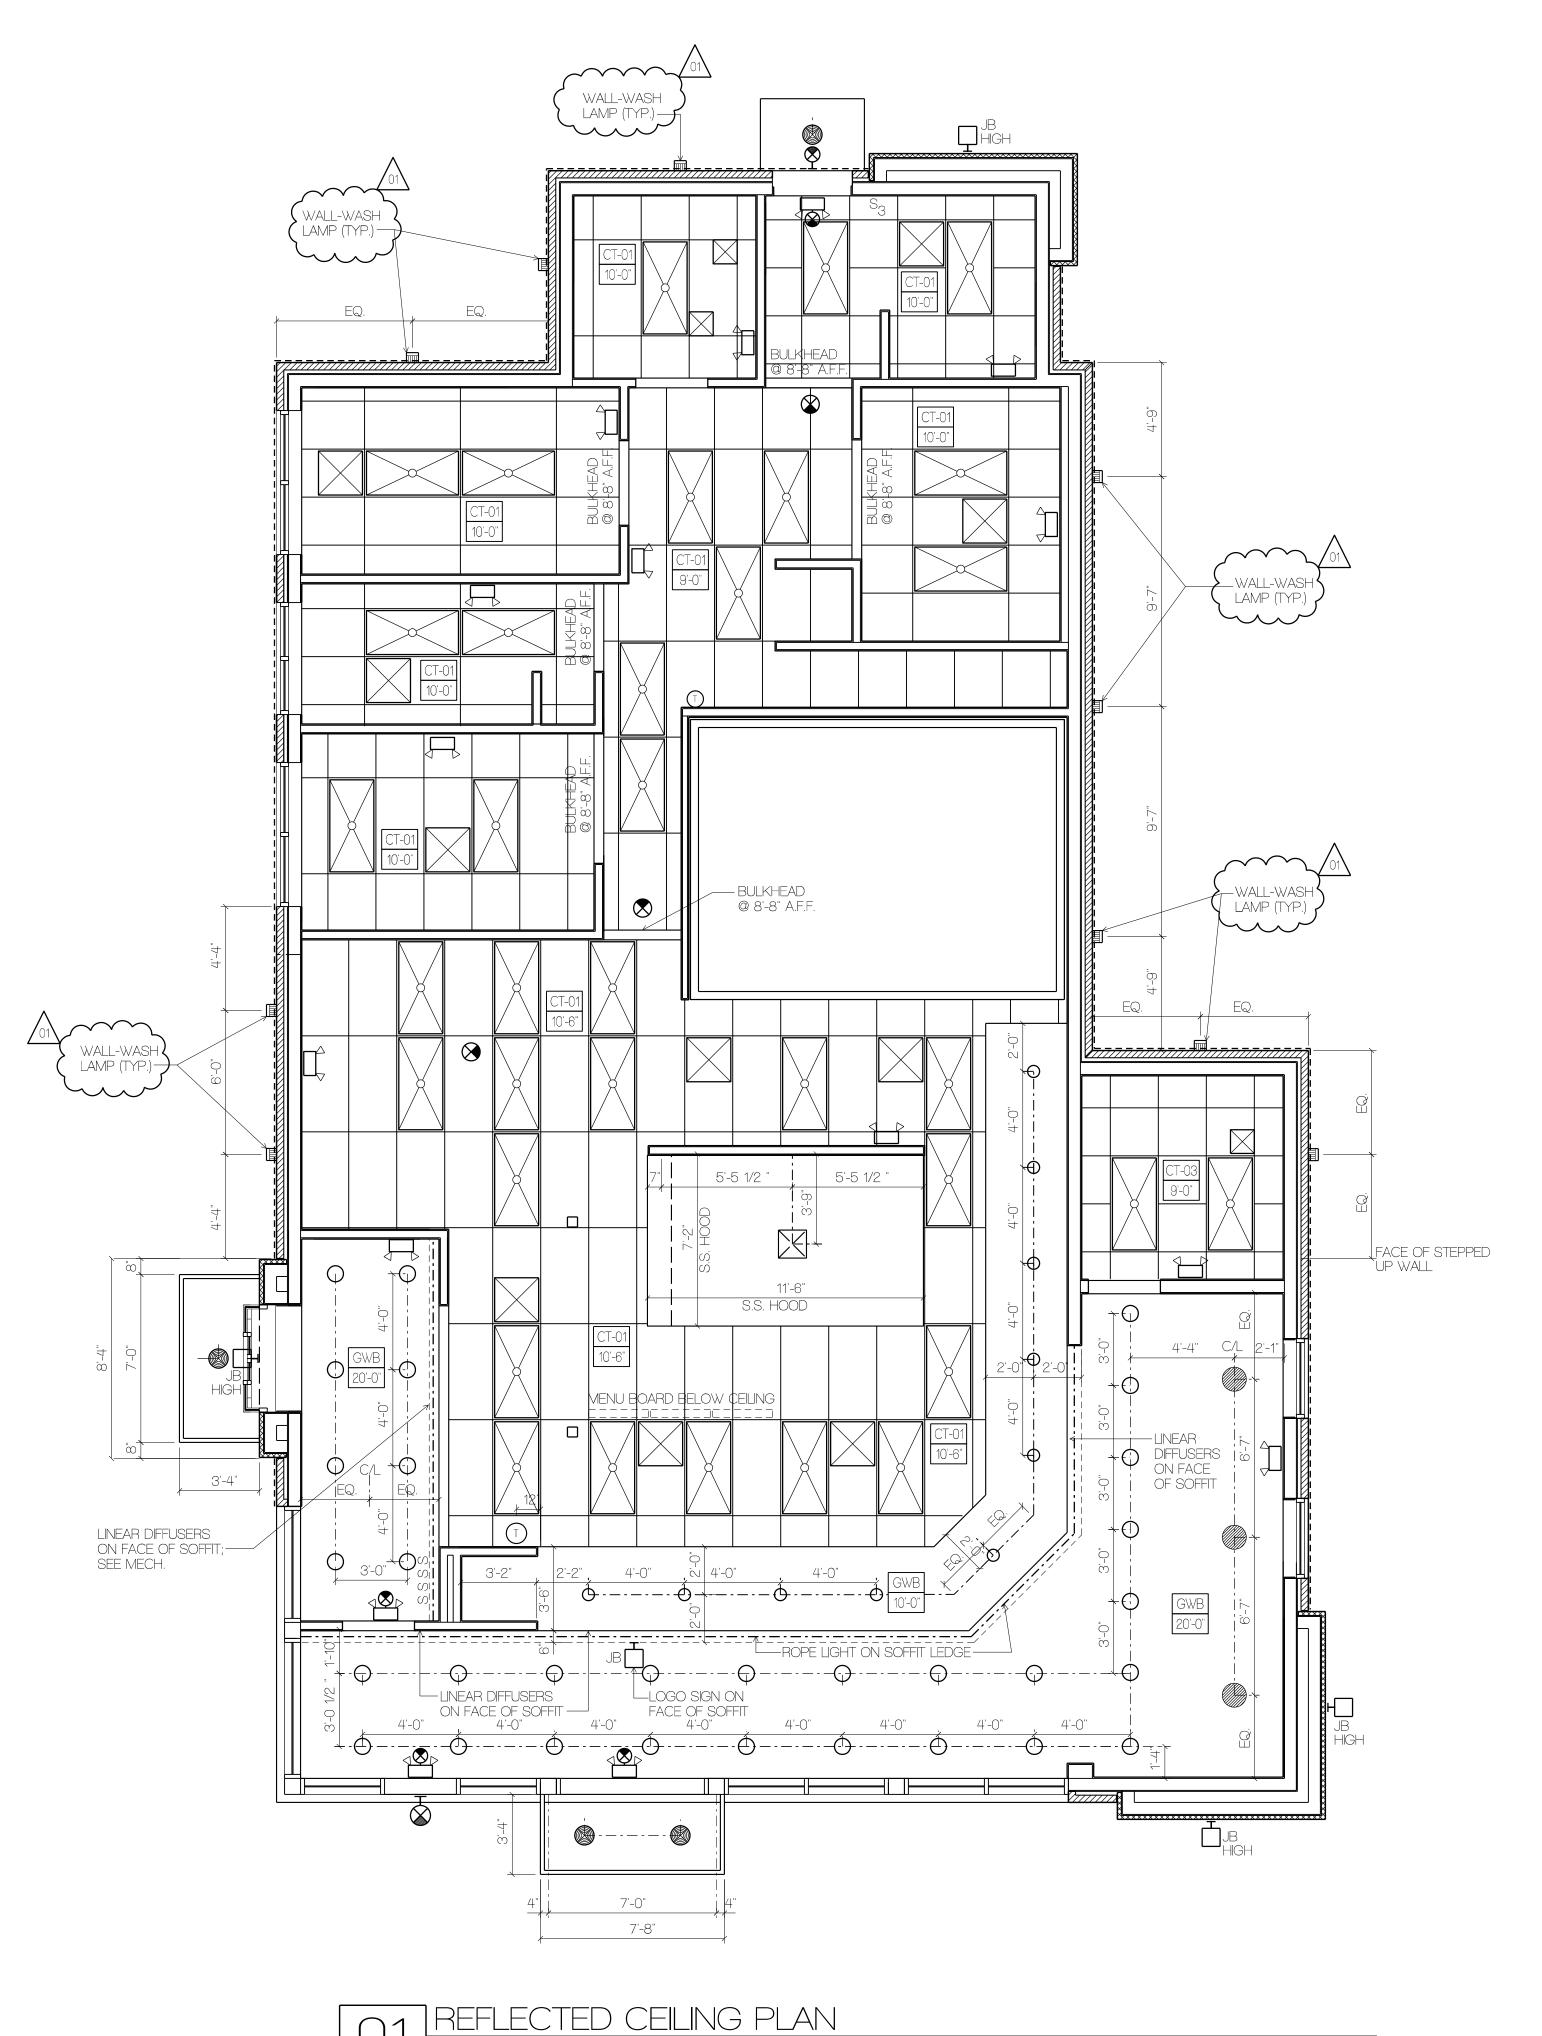

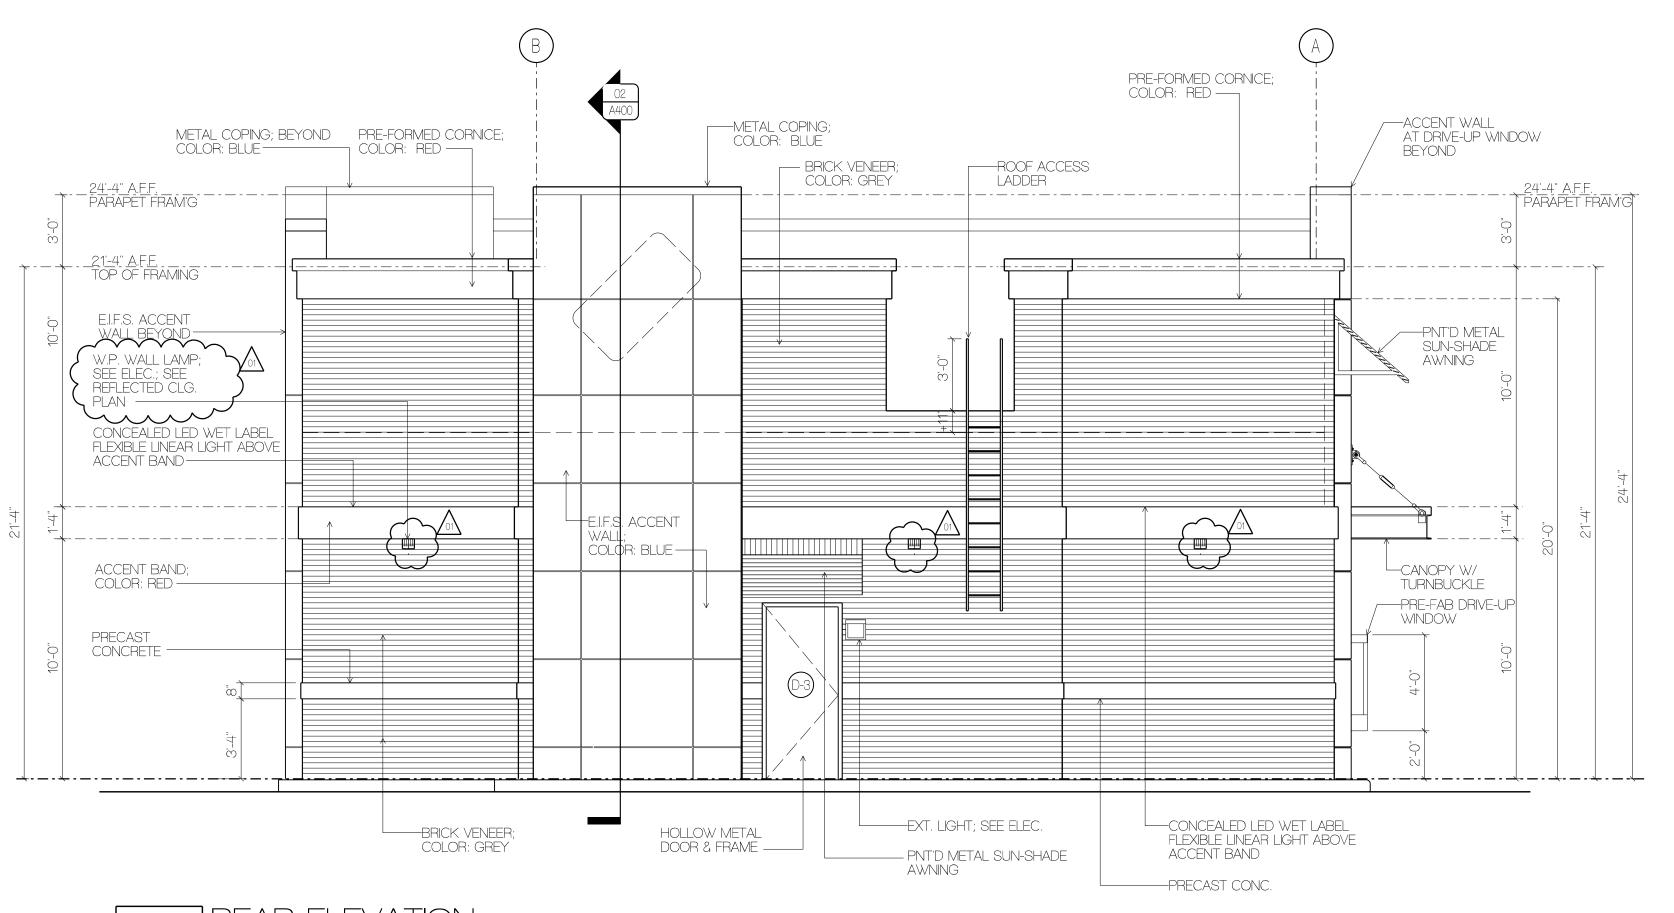



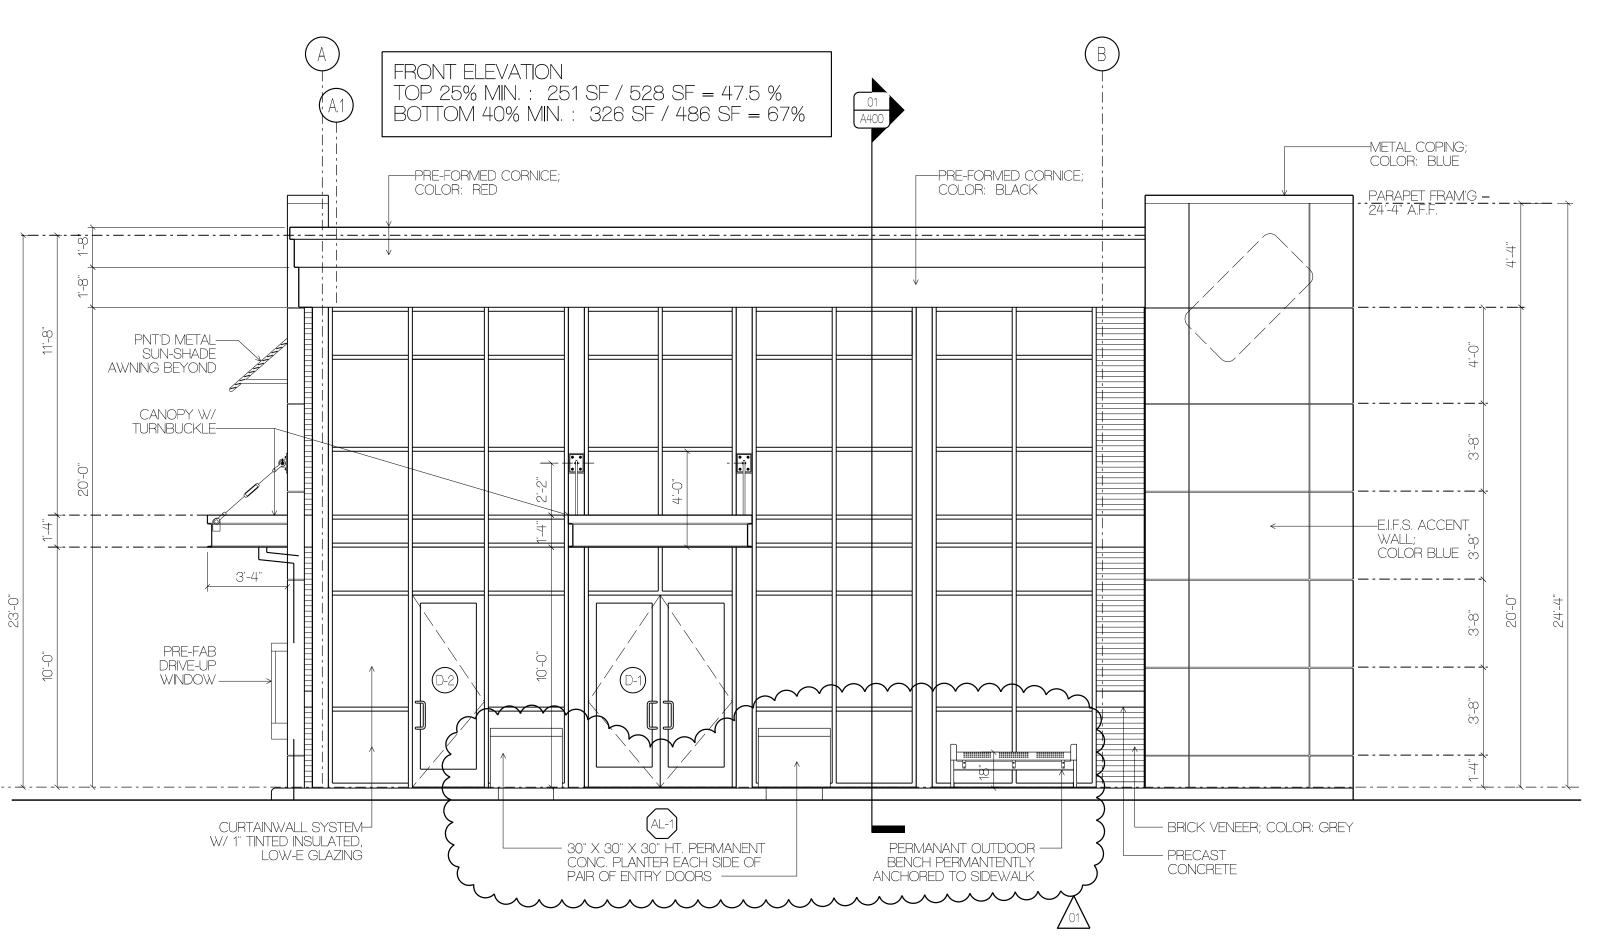

O1 FRONT (HENDRICKS DRIVE) ELEVATION

SCALE: 1/4" = 1'-0"



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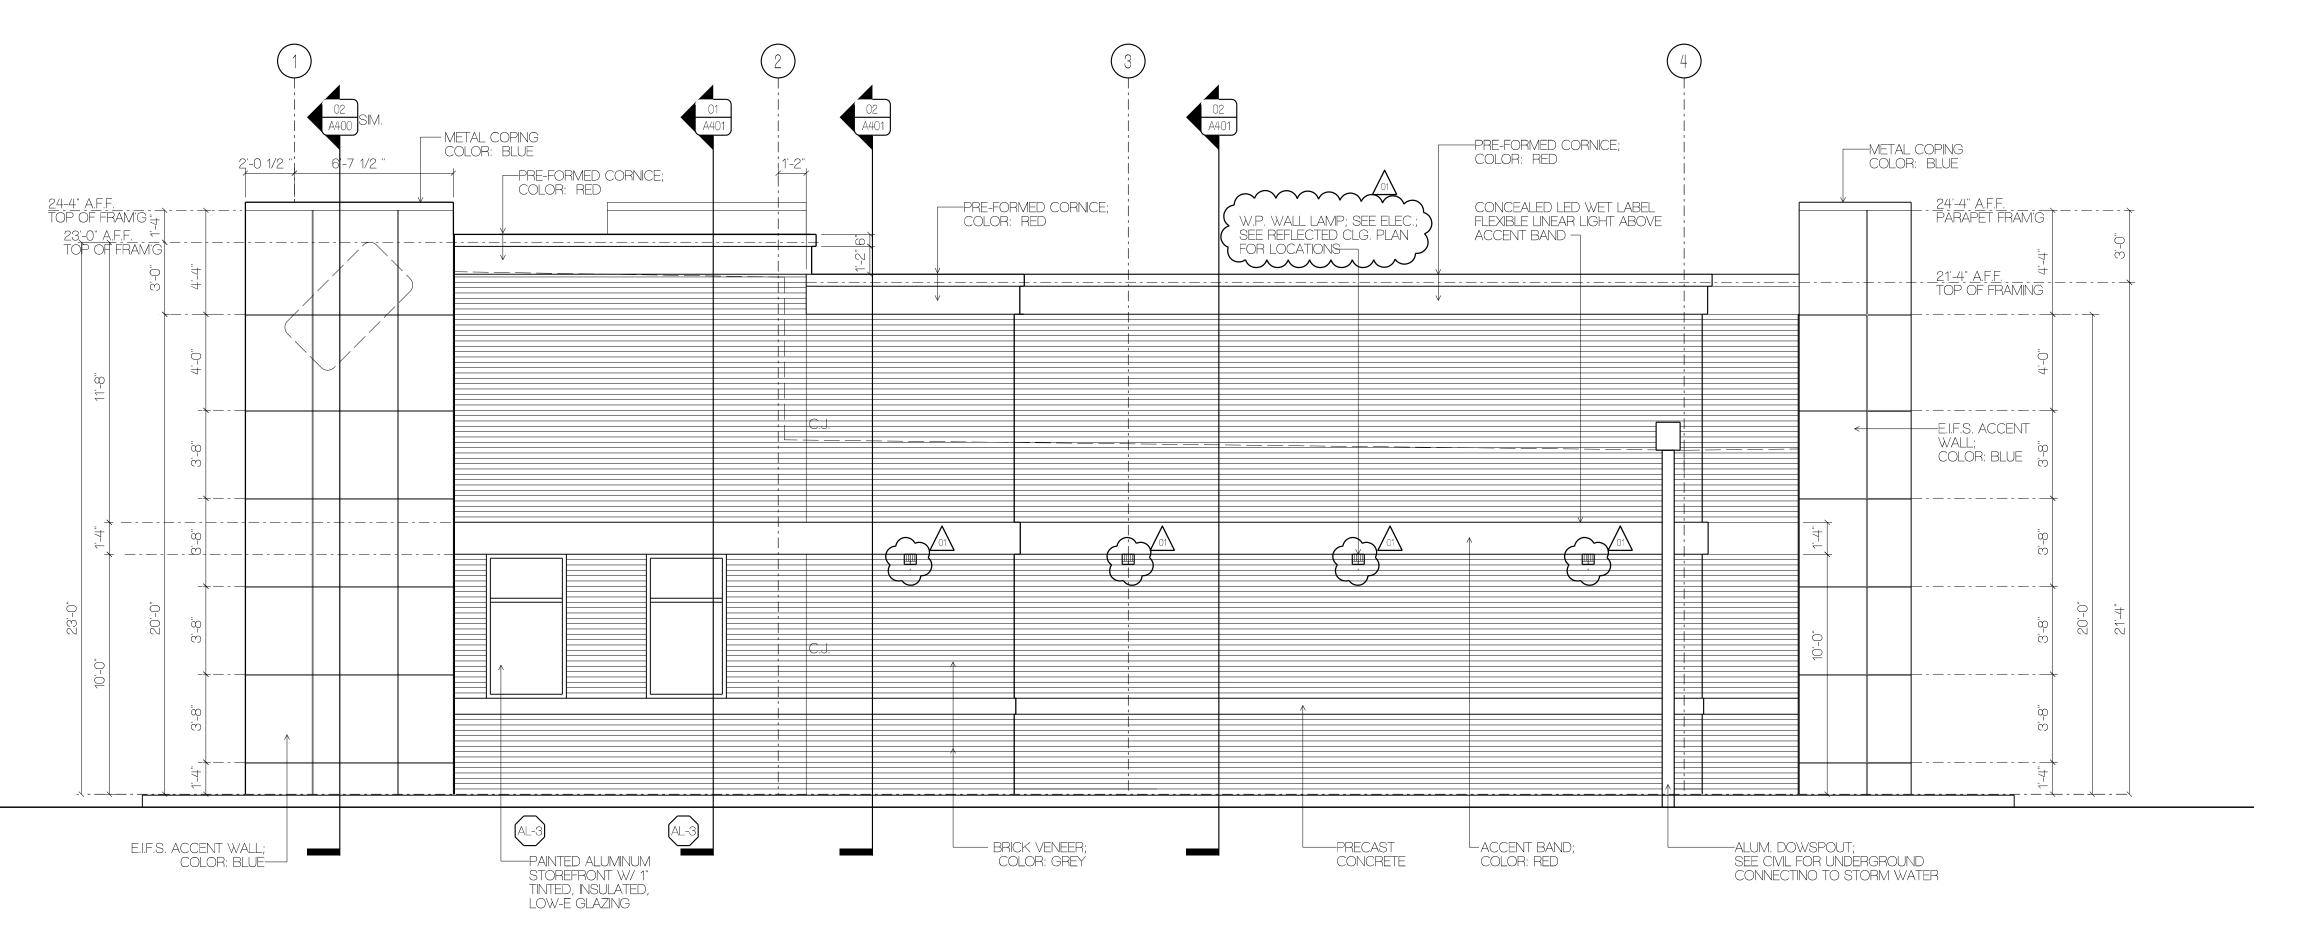
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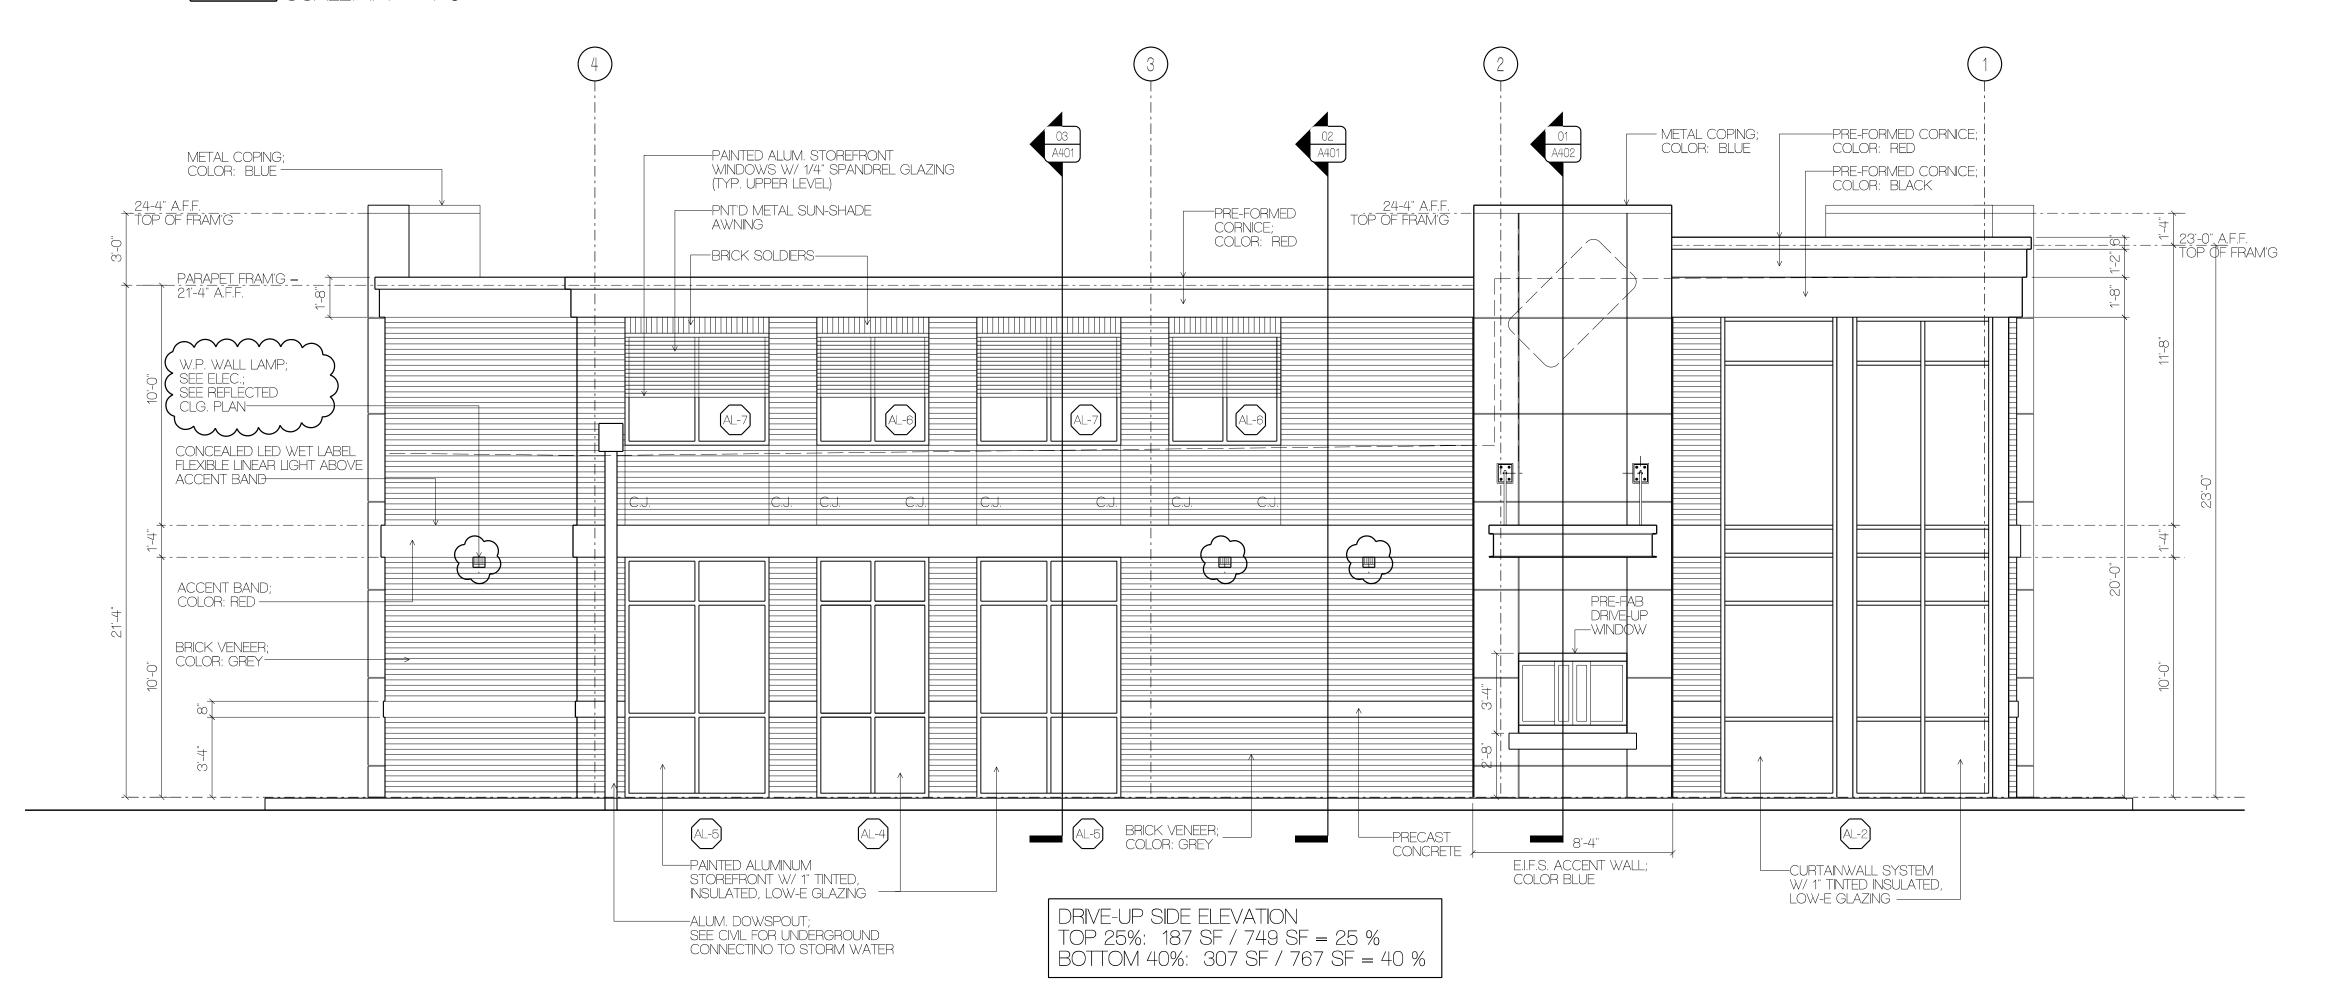
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EXTERIOR ELEVATIONS

A200








O1 LEFT (DRIVE-UP) ELEVATION

SCALE: 1/4" = 1'-0"



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10.05.23 TOWN OF ZEBULON ZONING REVISIONS
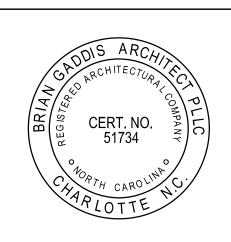
> EXTERIOR ELEVATIONS

> > A201